

JAPARA
HEALTHCARE

JAPARA HEALTHCARE - CARLINGFORD AGE CARE FACILITY

**47 MURRAY FARM ROAD,
CARLINGFORD, NSW, 2118**

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BASEMENT PLAN


1 : 200 @ A1

23.09.2019

rev. B



0 2 4 6 10
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JAPARA
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JAPARA HEALTHCARE - CARLINGFORD AGED CARE FACILITY
47 MURRAY FARM ROAD,
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JAPARA HEALTHCARE

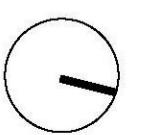

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JAPARA
PROPERTY[®]

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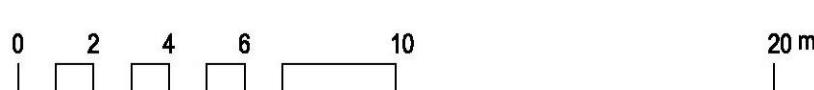
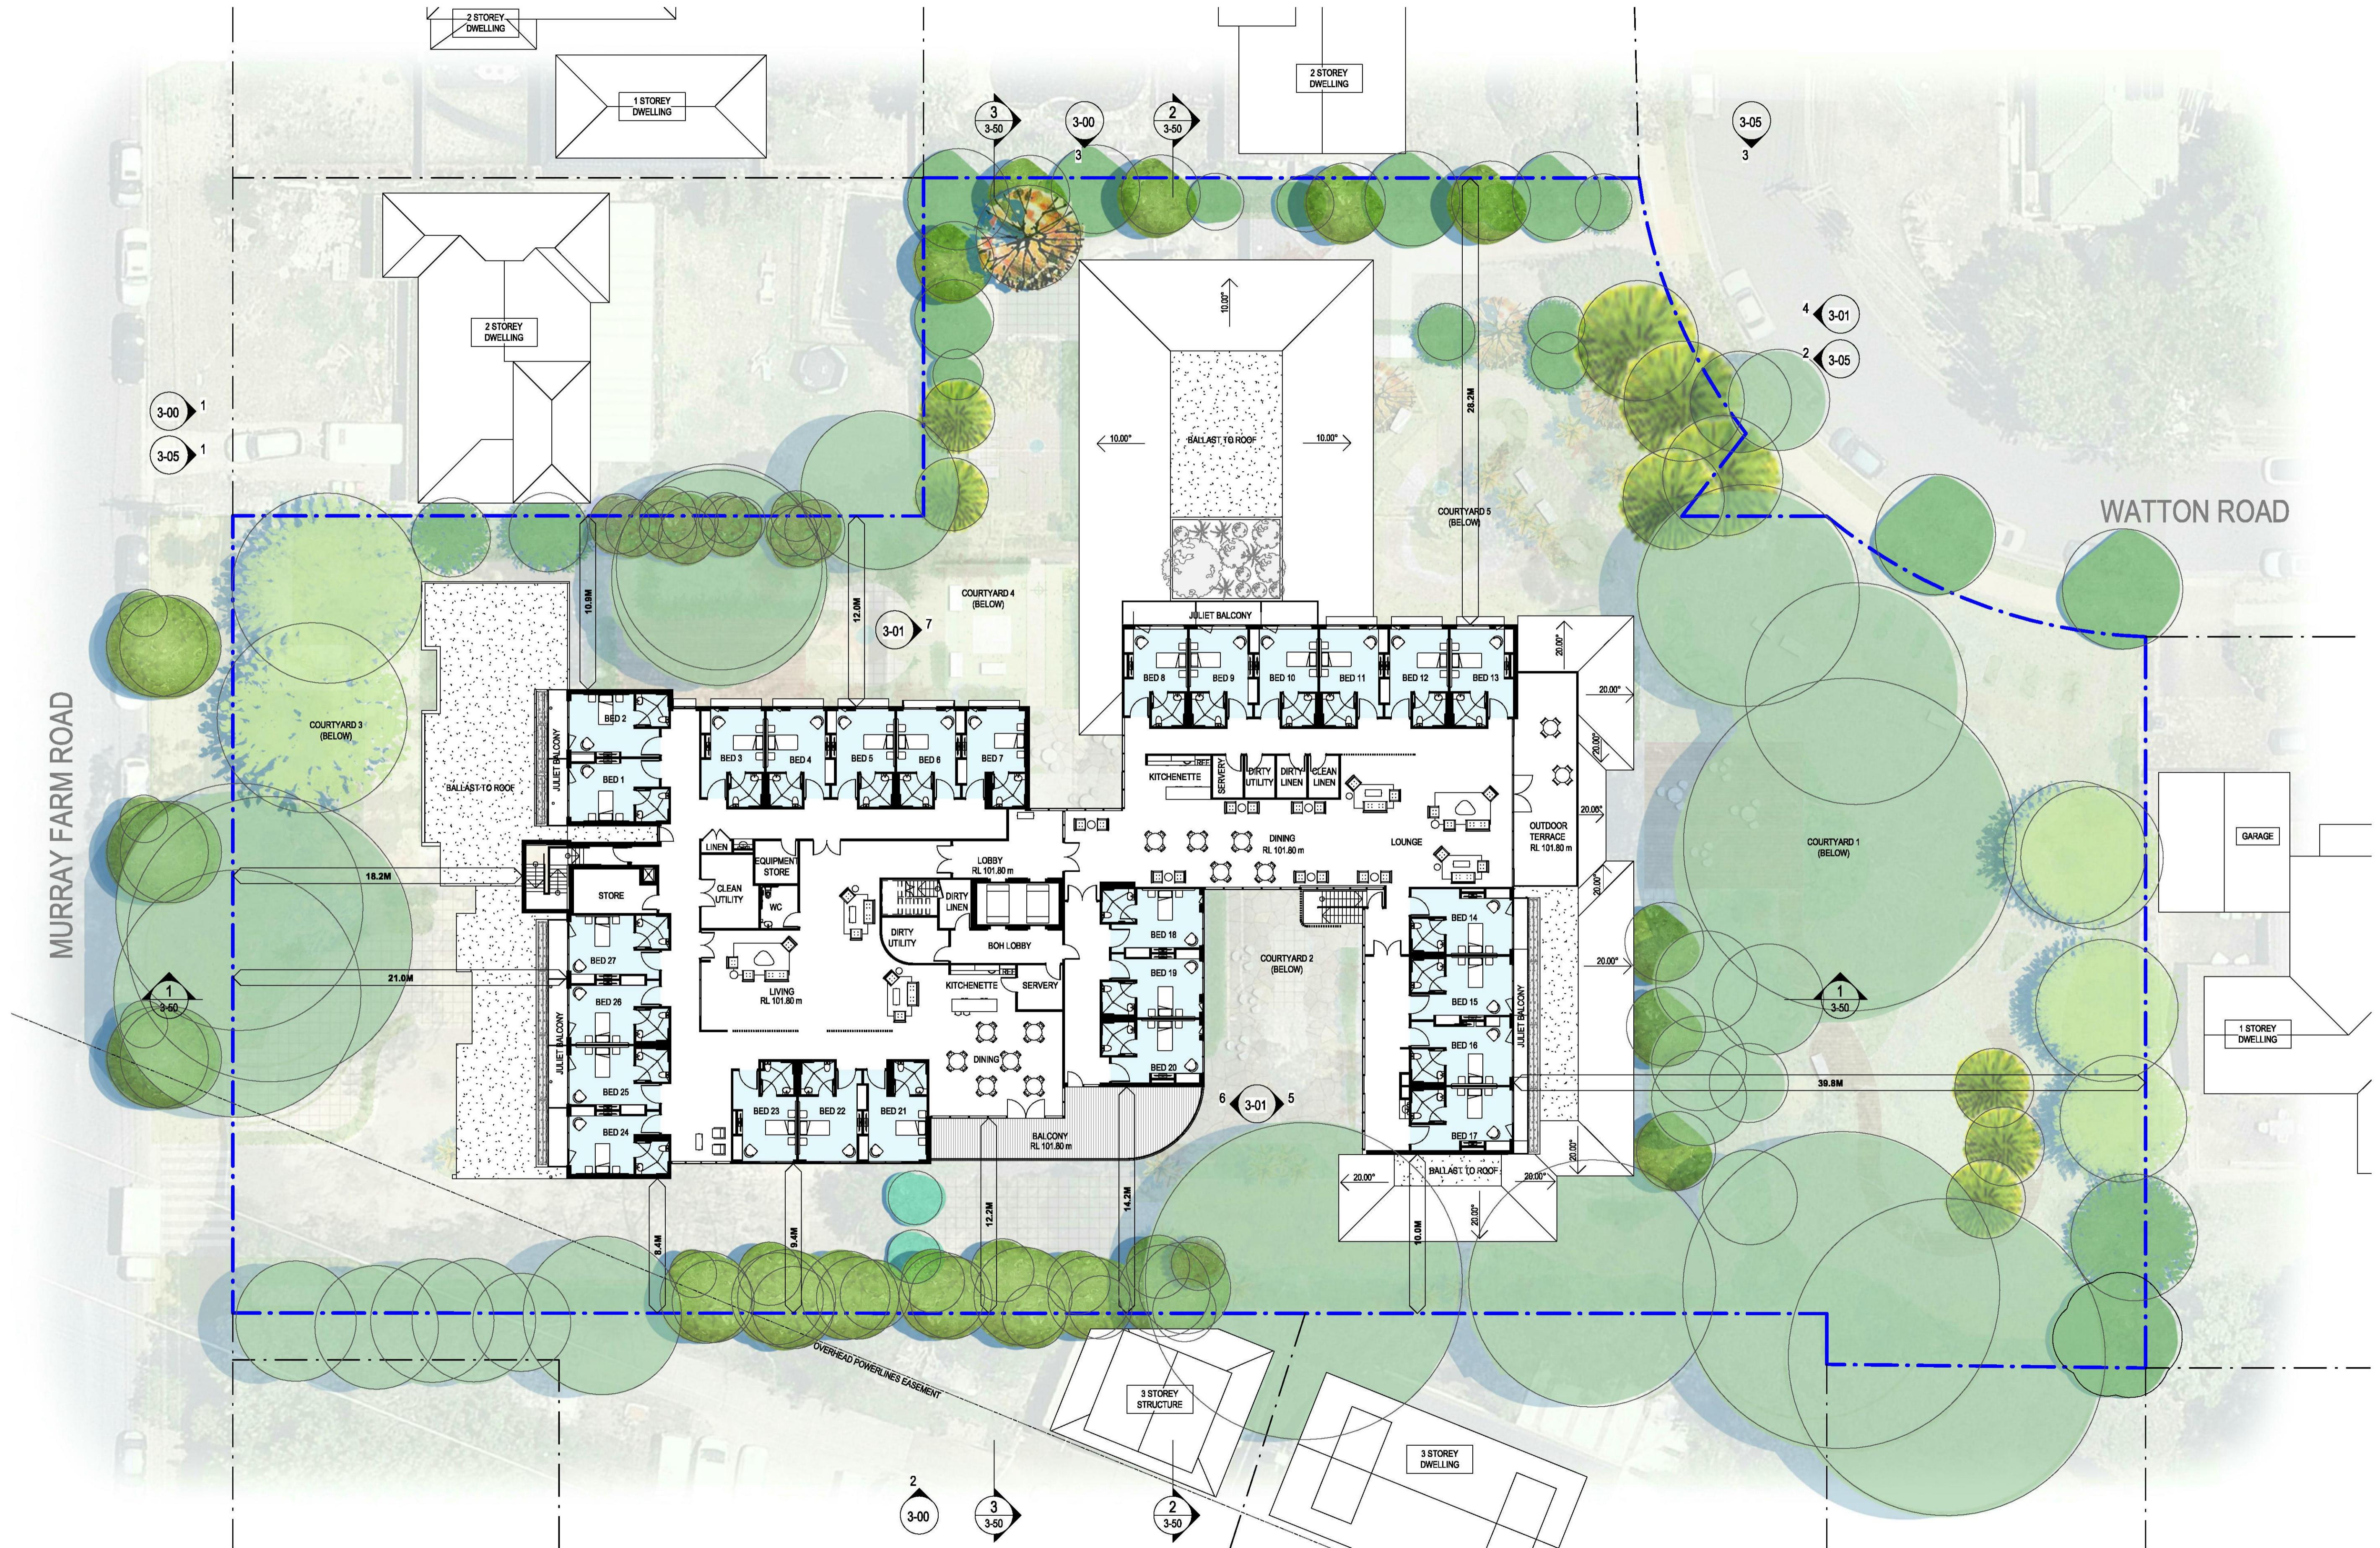
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TA # 18.0119.12 DA2-02

LEVEL 1 PLAN

1 : 200 @ A1

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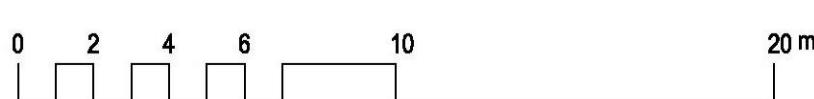
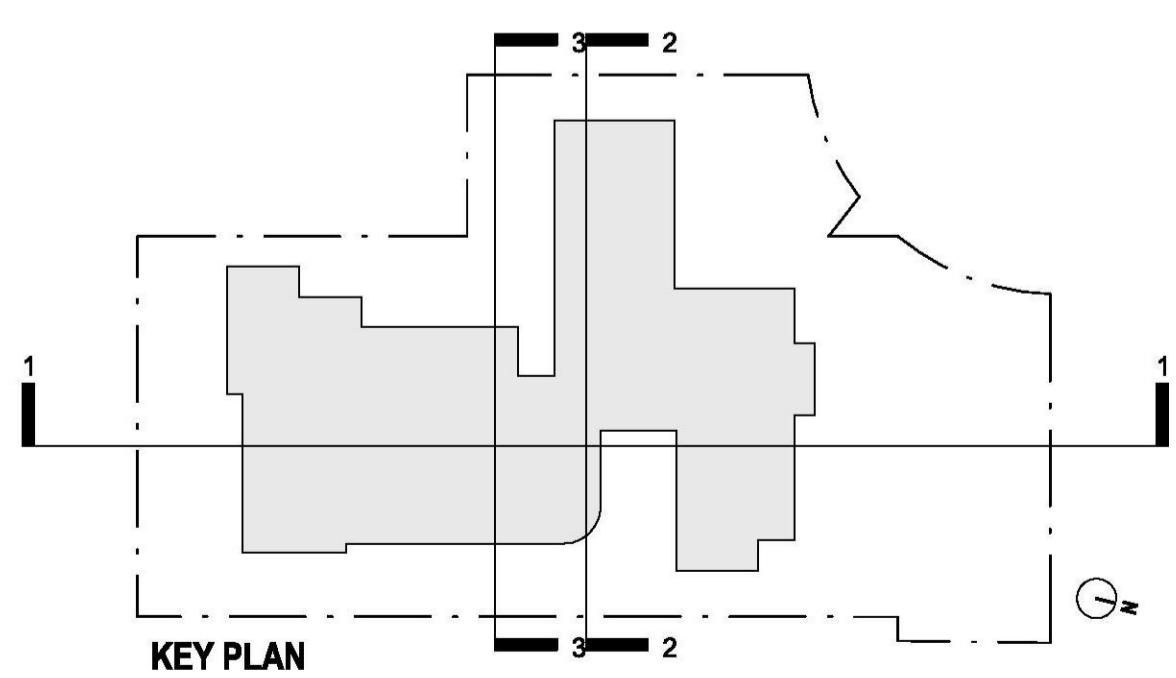
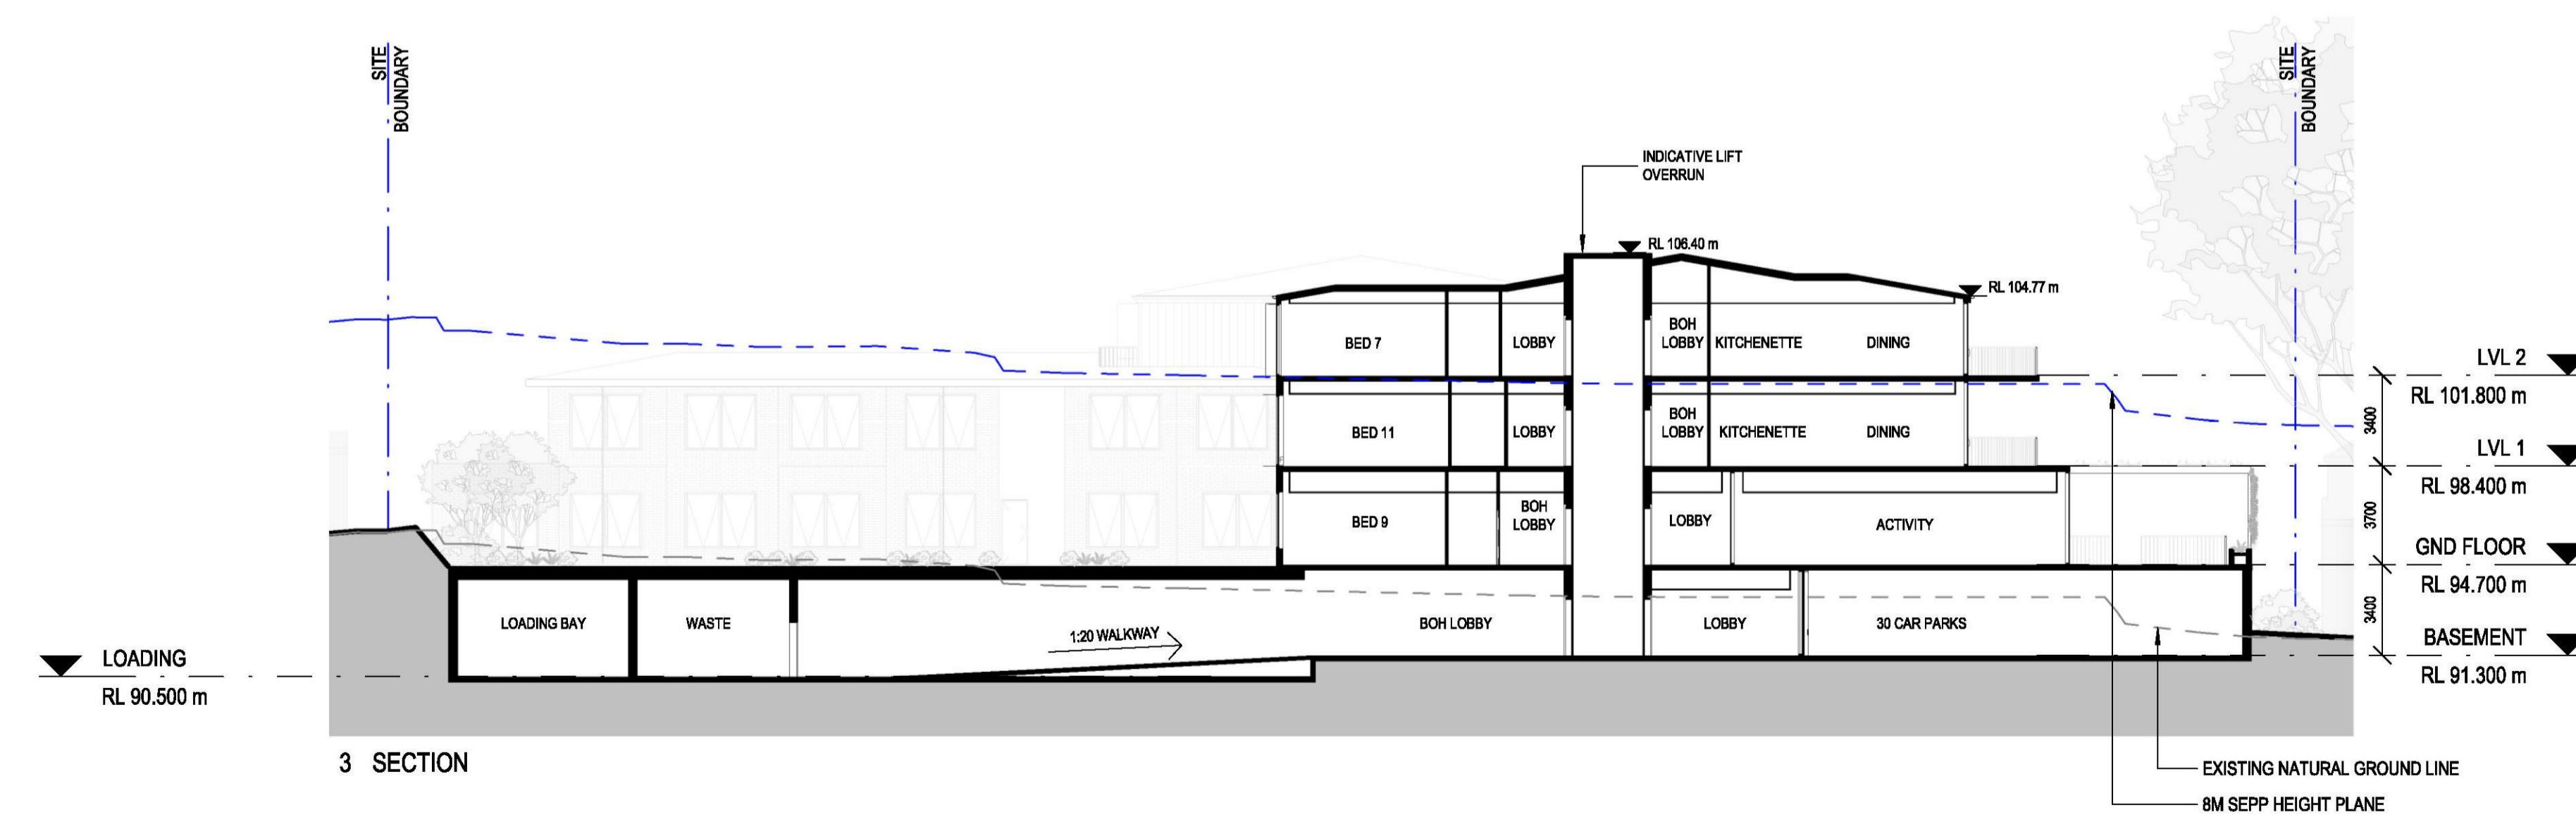
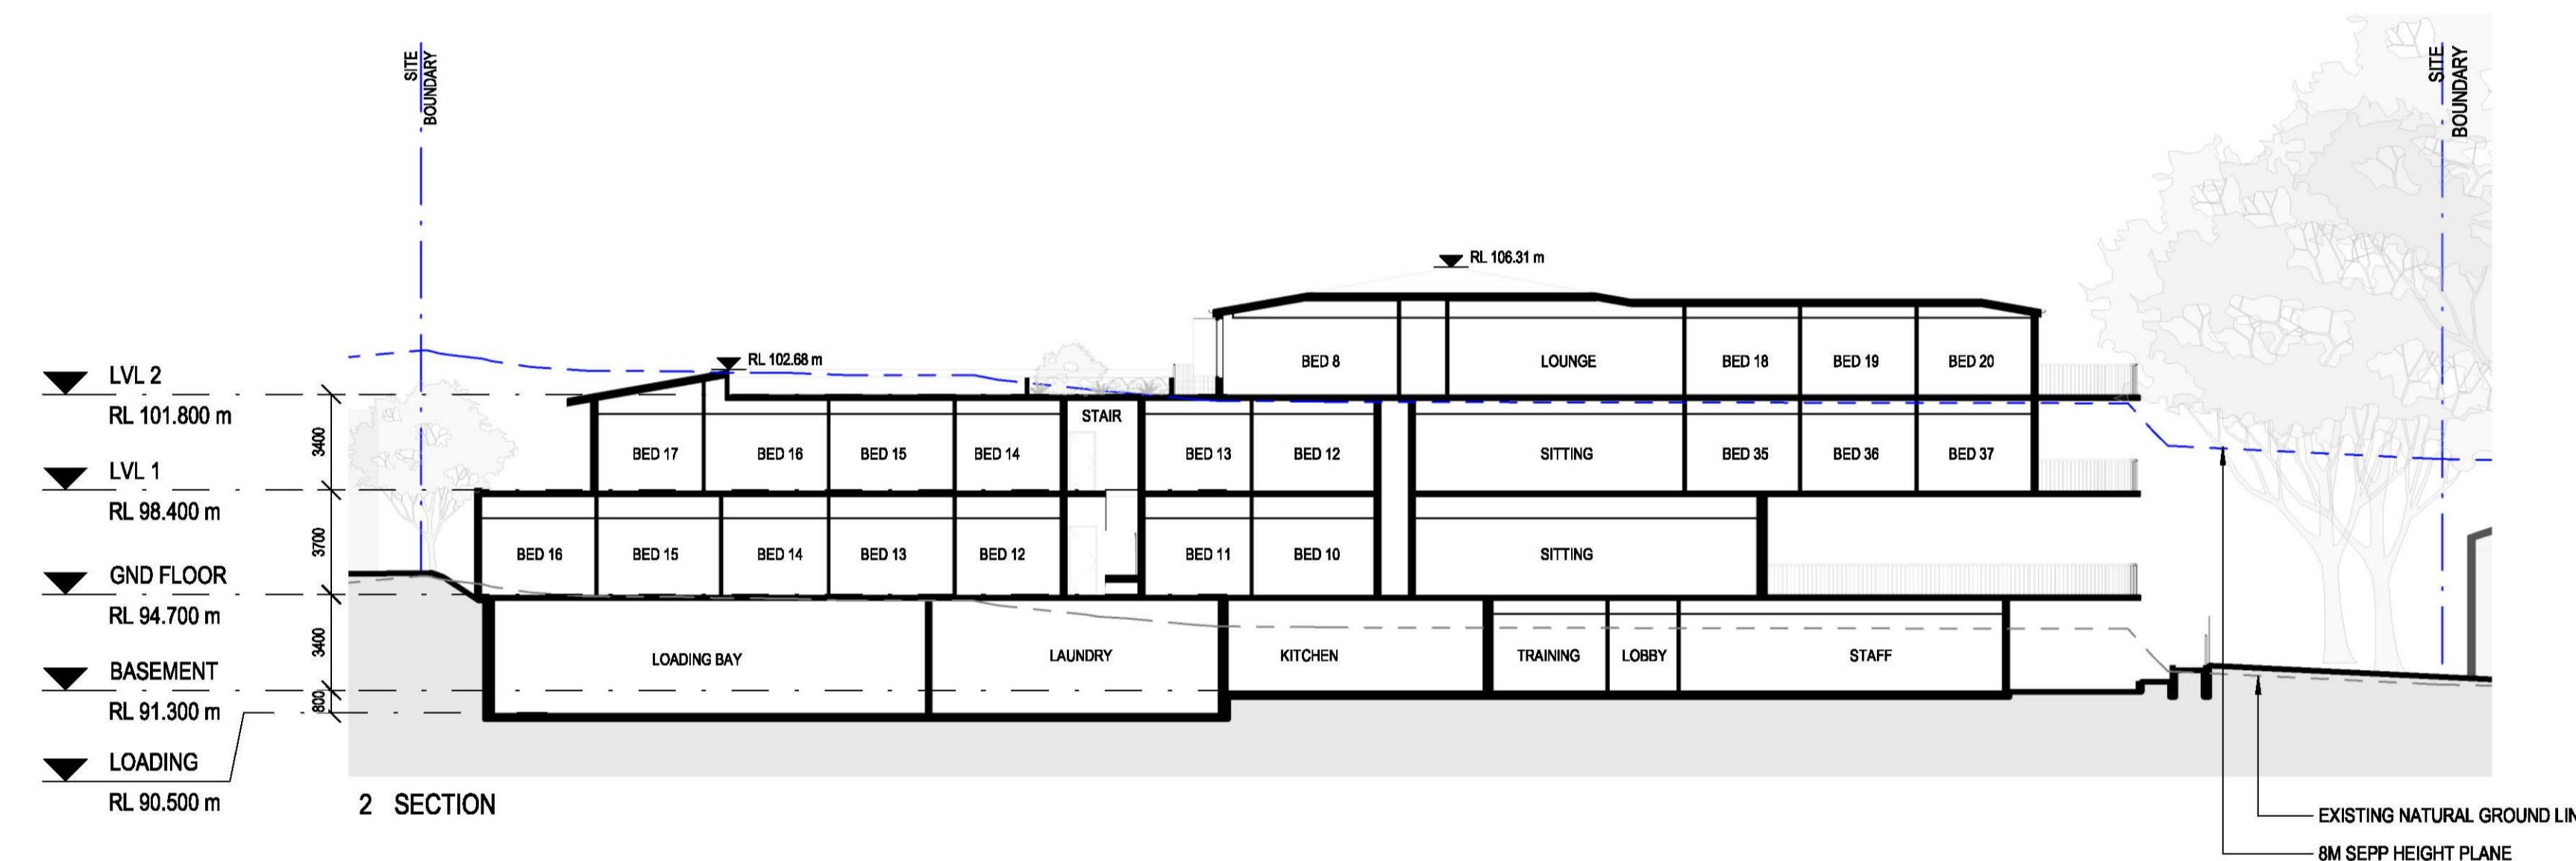
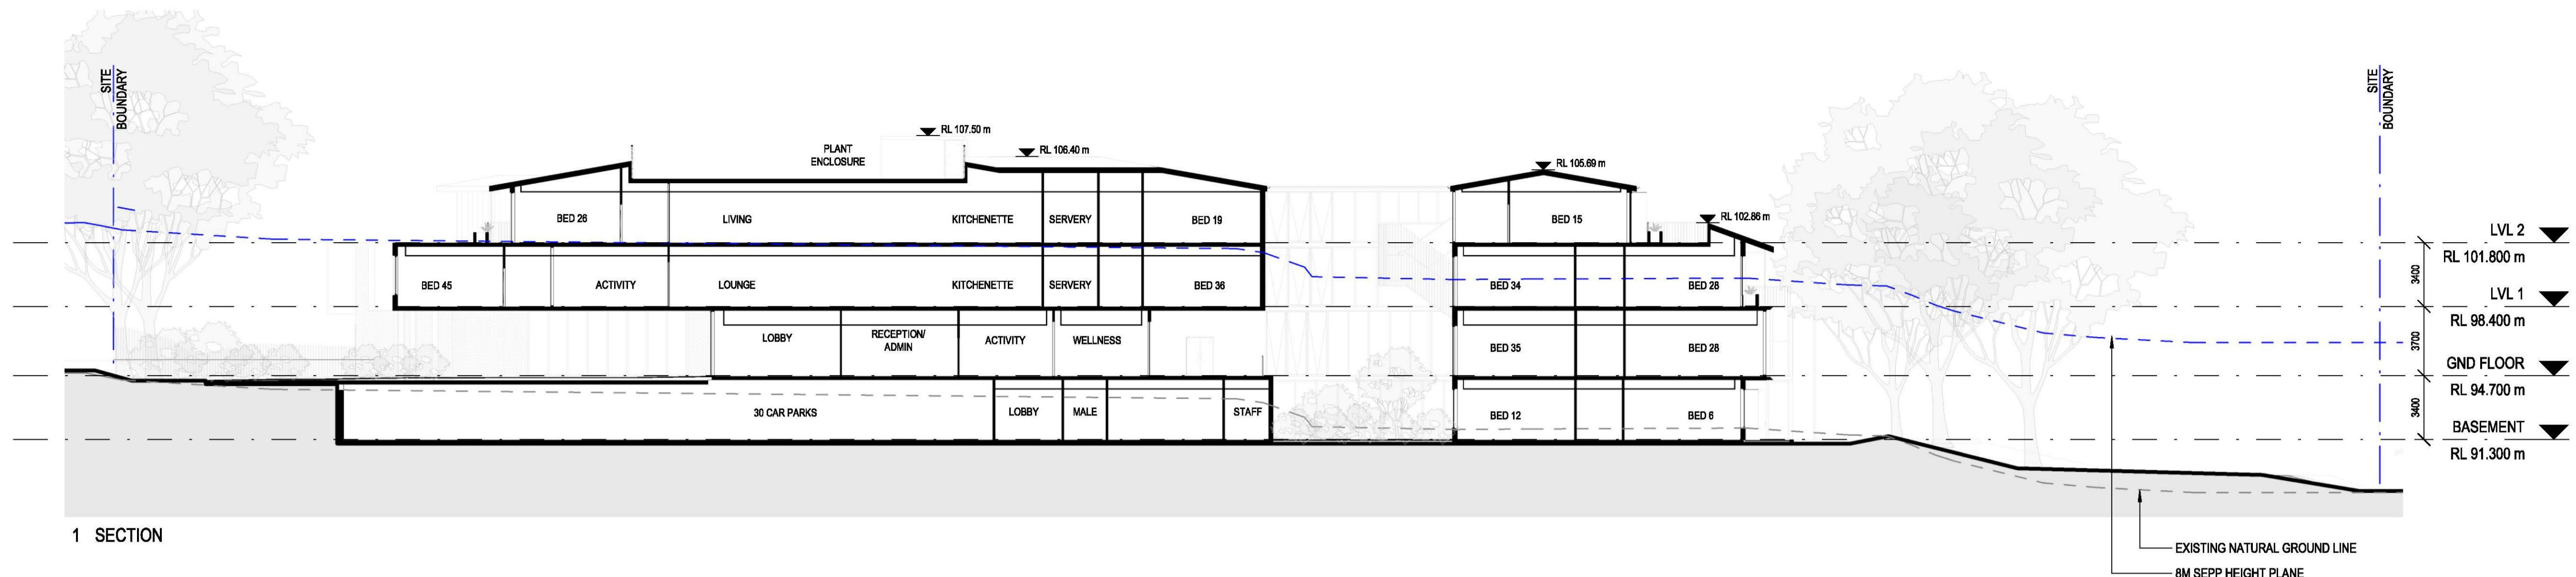
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| FVEI 2 PLAN

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CARE FACILITY
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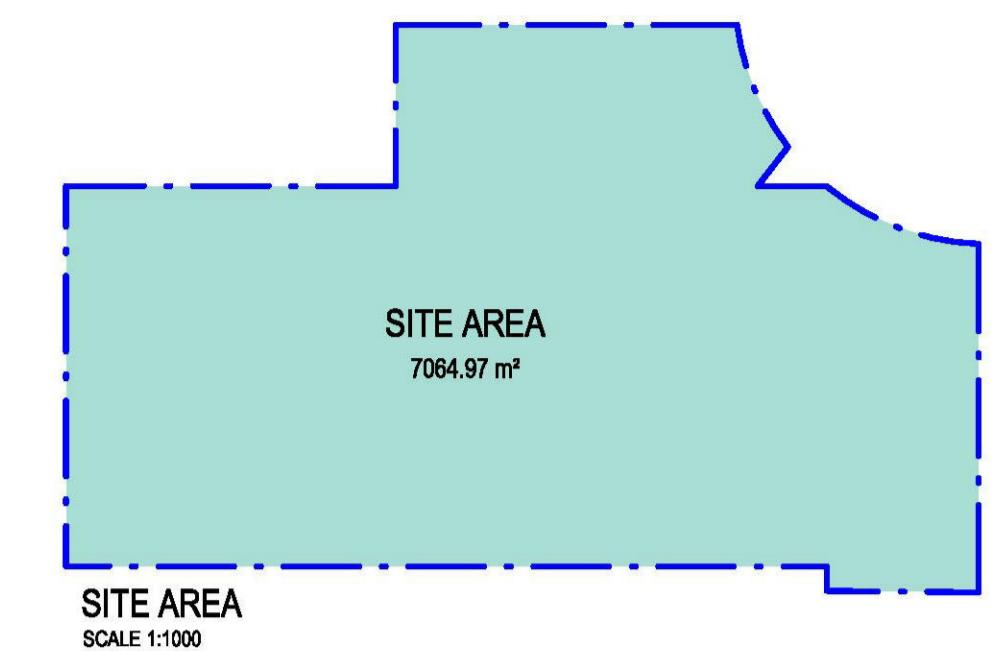
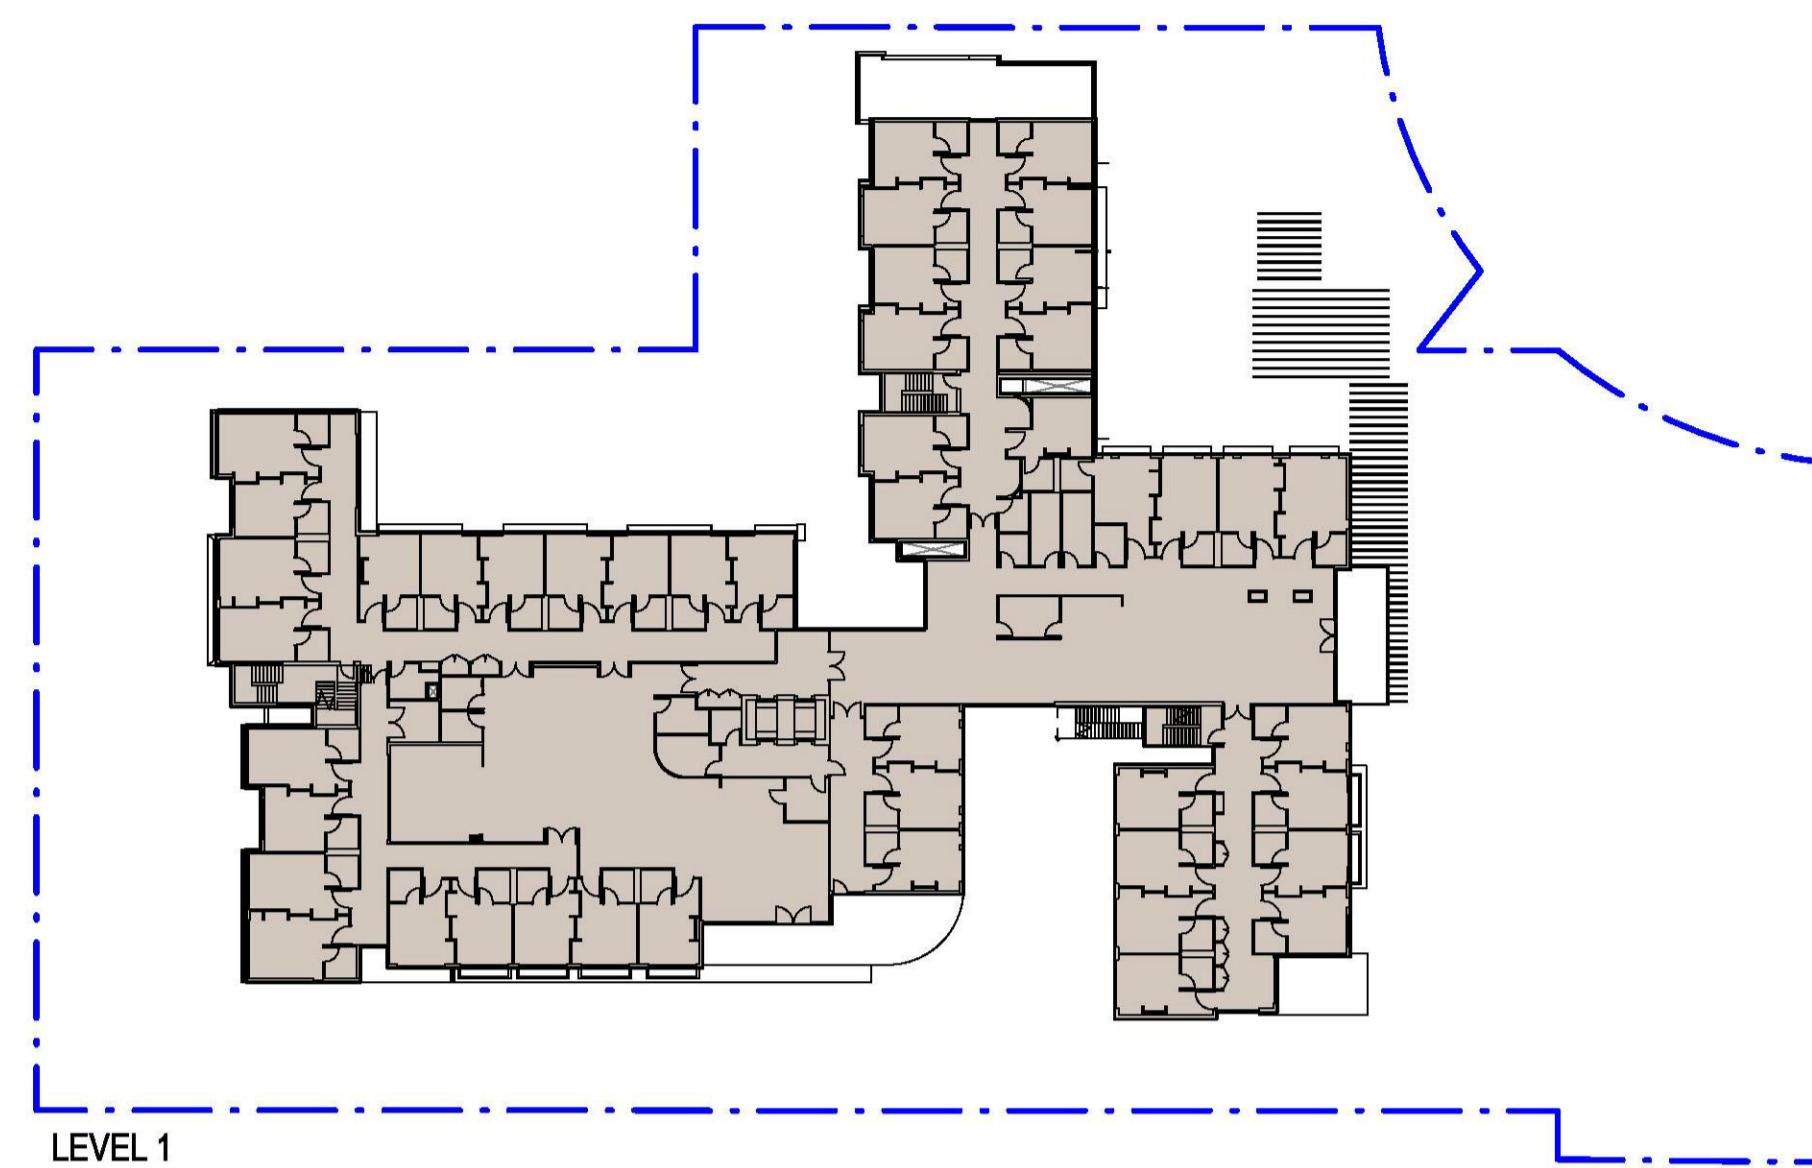
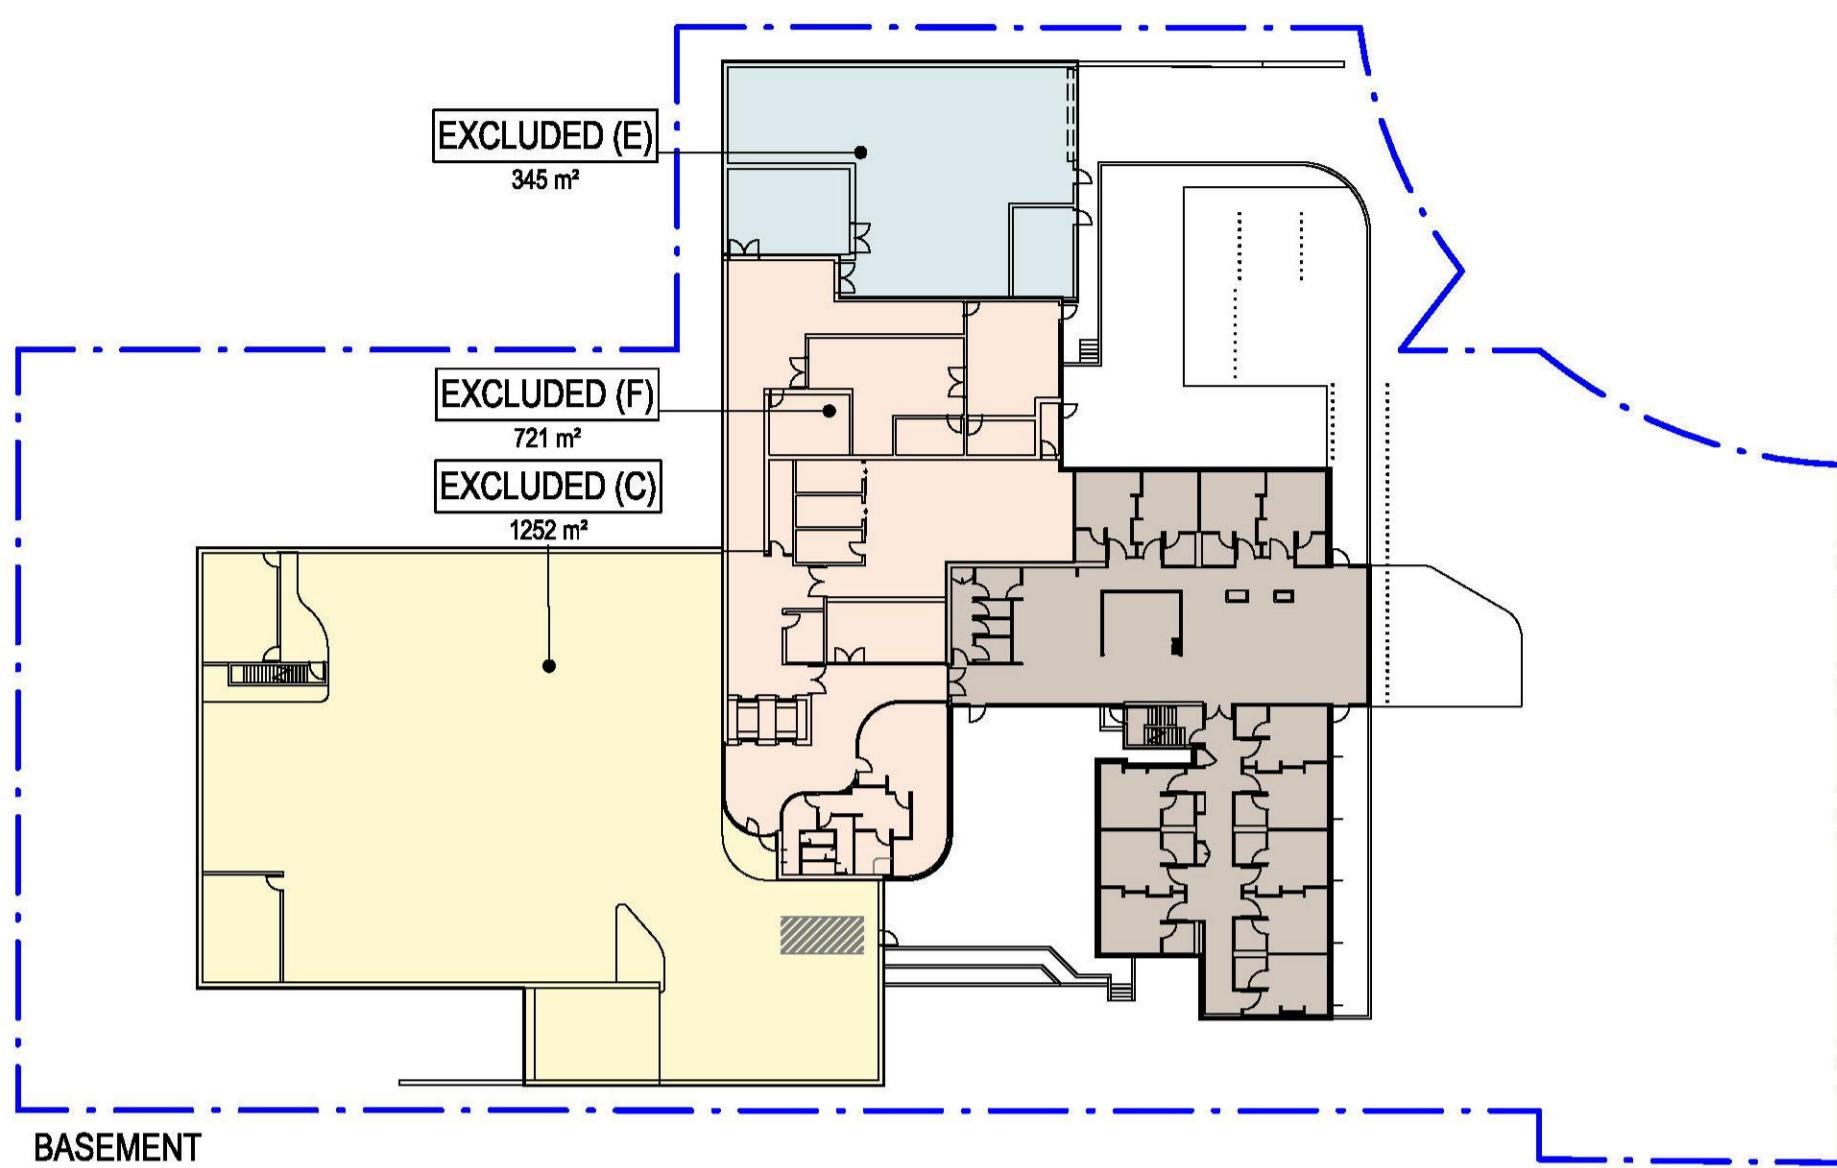
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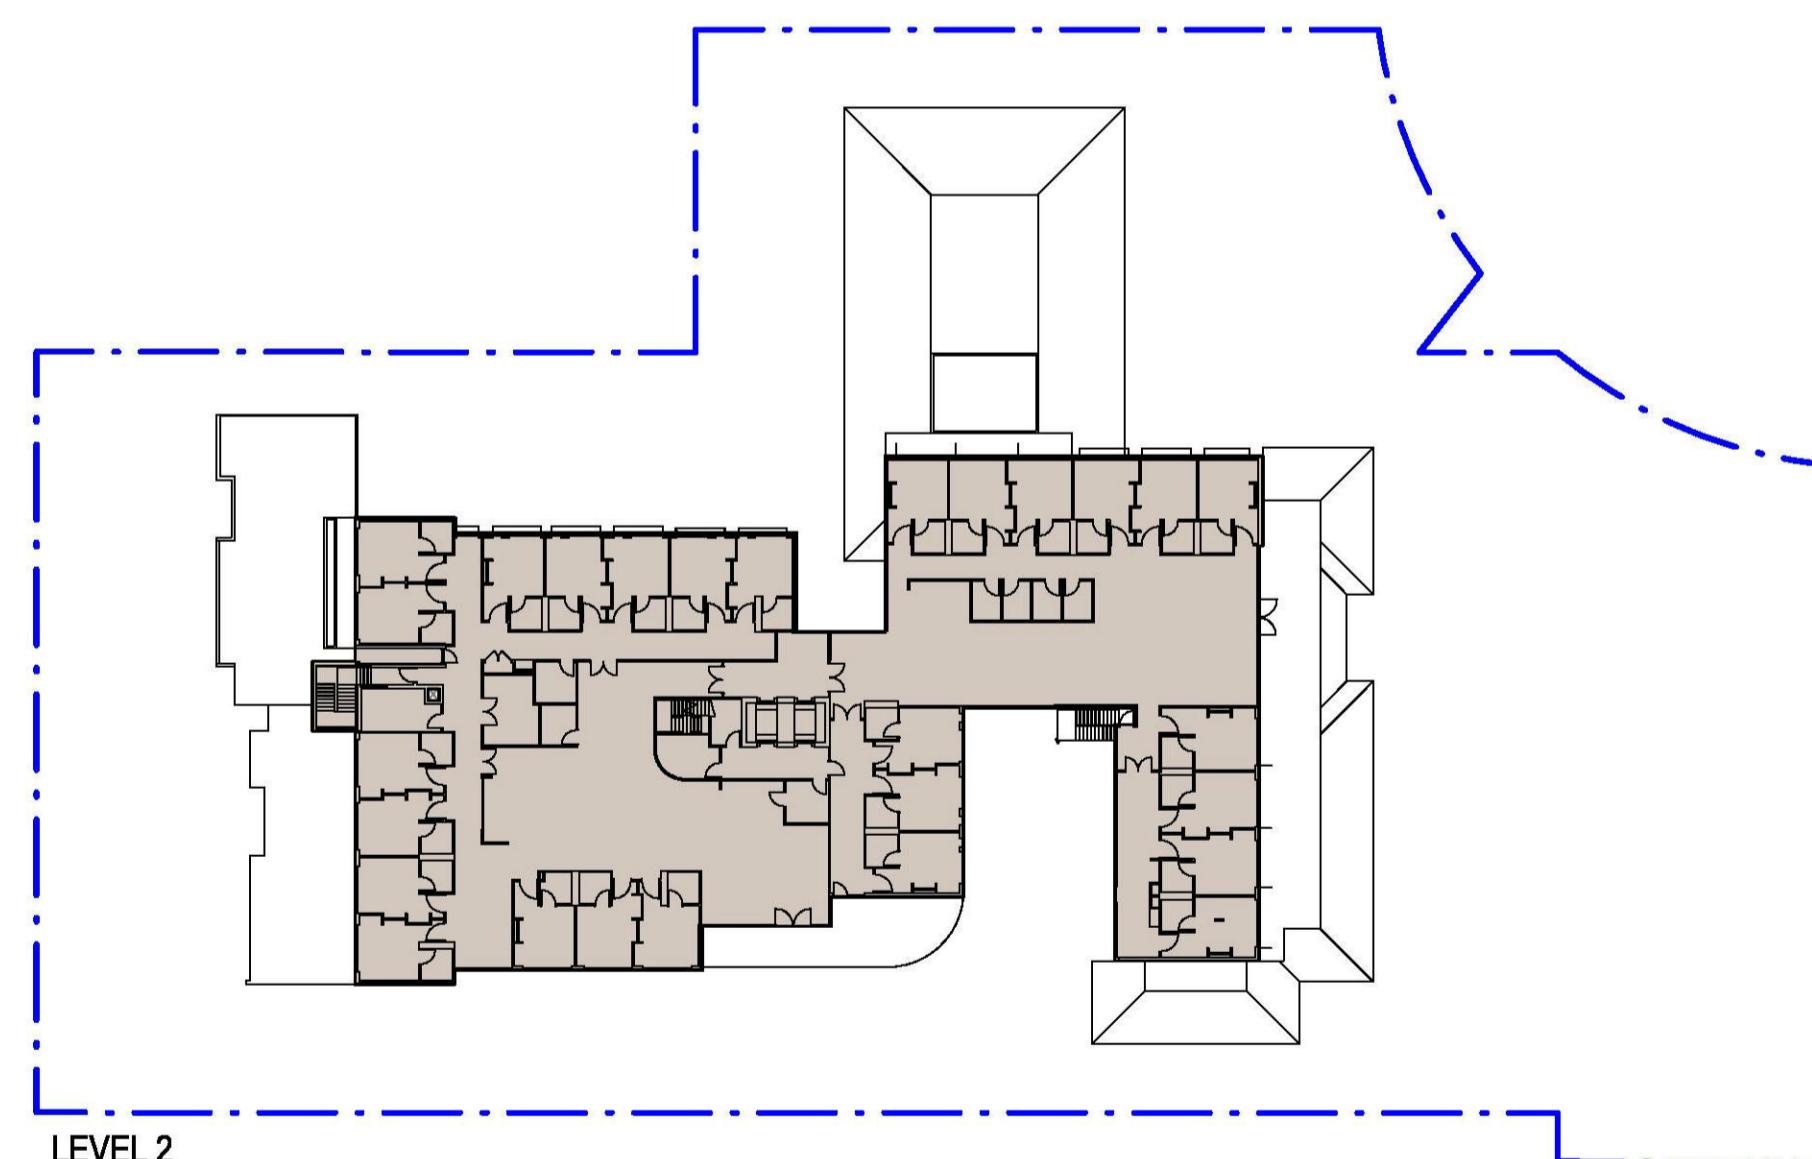
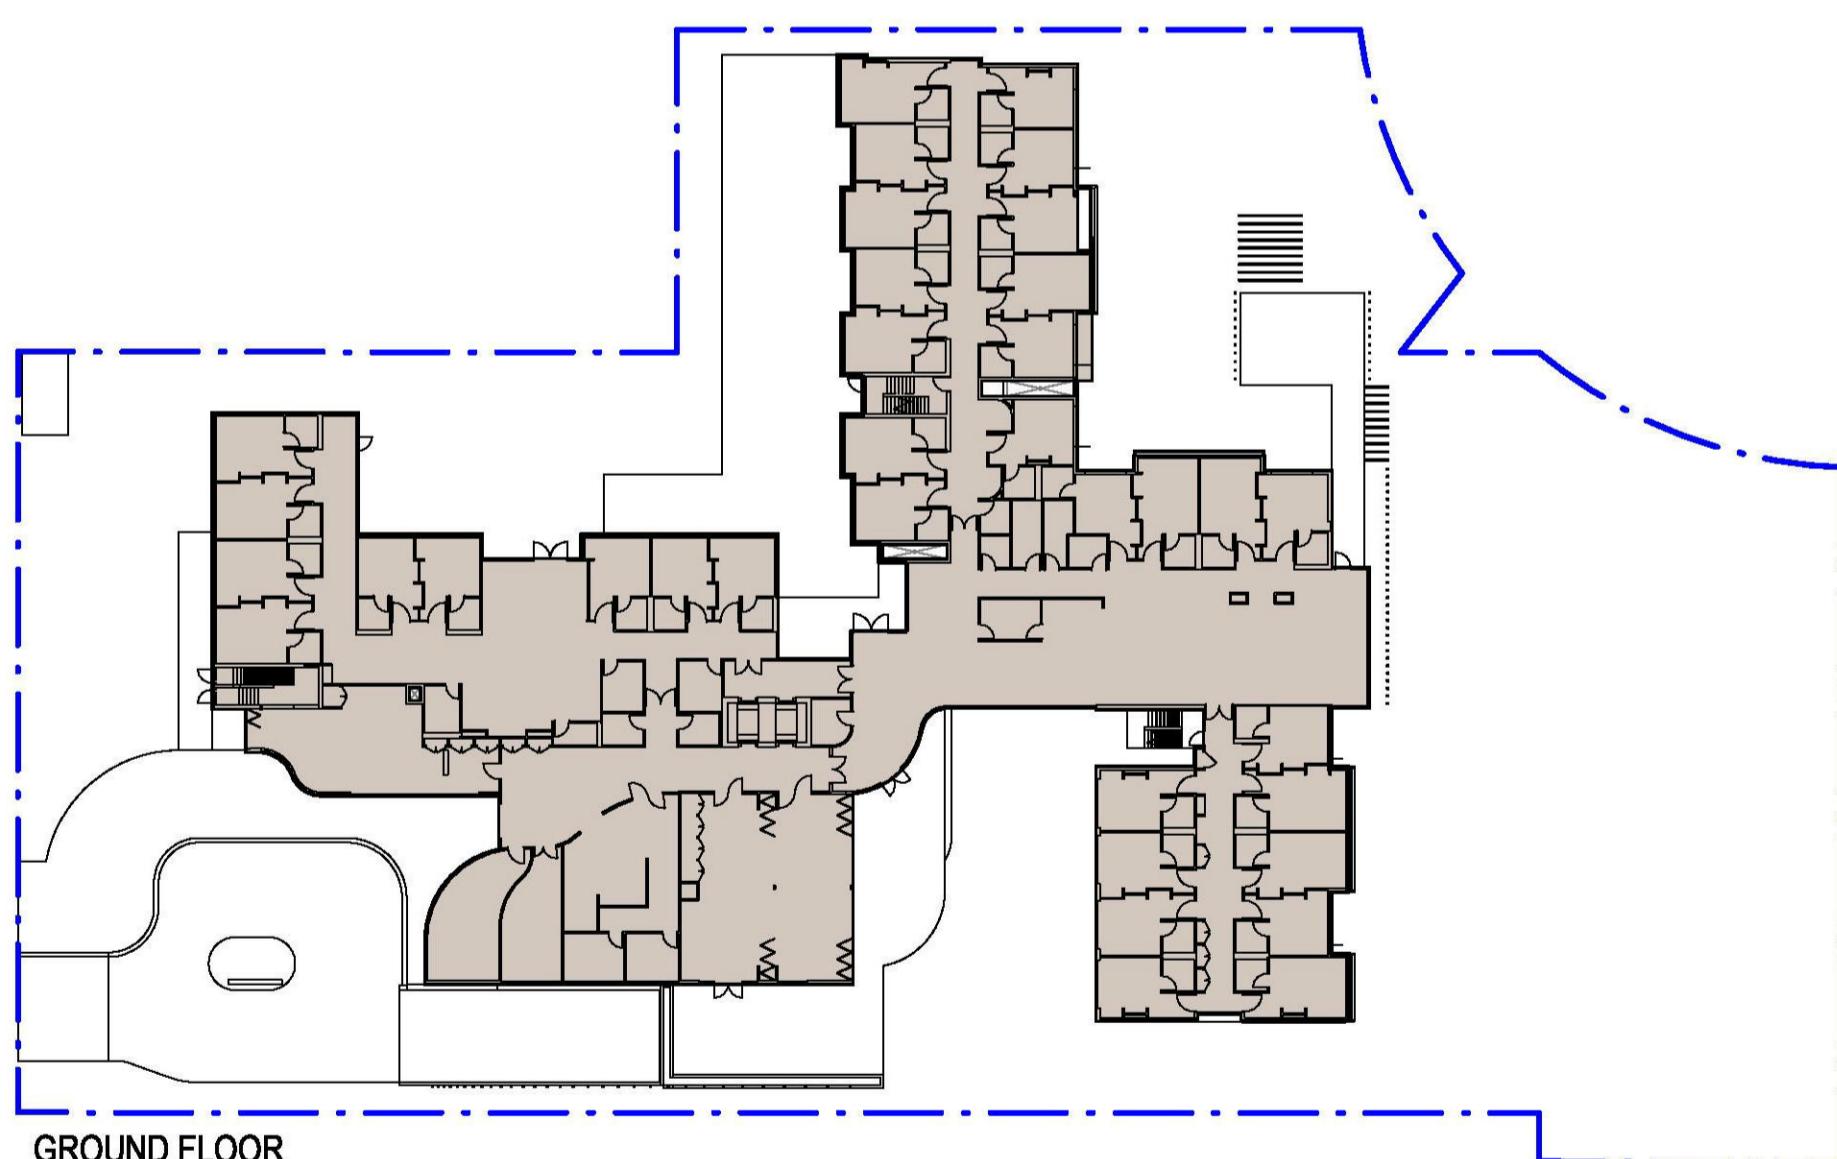
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BUILDING SECTIONS

rev B




GFA SCHEDULE	
LEVEL	AREA
BASEMENT	654 m ²
GROUND FLOOR	2327 m ²
LEVEL 1	2408 m ²
LEVEL 2	1596 m ²
TOTAL GFA	6985 m ²
PROPOSED FSR	1:0.99



DEFINITION OF GFA:
Gross Floor Area means the sum of the areas of each floor of a building, where the area of each floor is taken to be the area within the outer face of the external enclosing walls (as measured at a height of 1,400 millimetres above each floor level):

- a. excluding columns, fin walls, sun control devices and any elements, projections or works outside the general lines of the outer face of the external wall, and
- b. excluding cooling towers, machinery and plant rooms, ancillary storage space and vertical air conditioning ducts, and
- c. excluding car parking needed to meet any requirements of this Policy or the council of the local government area concerned and any internal access to such parking, and
- d. including in the case of in-fill self-care housing any car parking (other than for visitors) in excess of 1 per dwelling that is provided at ground level, and
- e. excluding space for the loading and unloading of goods, and
- f. in the case of a residential care facility—excluding any floor space below ground level that is used for service activities provided by the facility.

State Environmental Planning Policy (Housing for Seniors or People with a Disability) 2004 [2004-143]

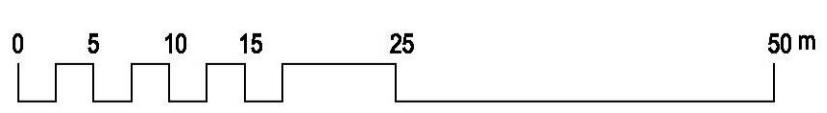

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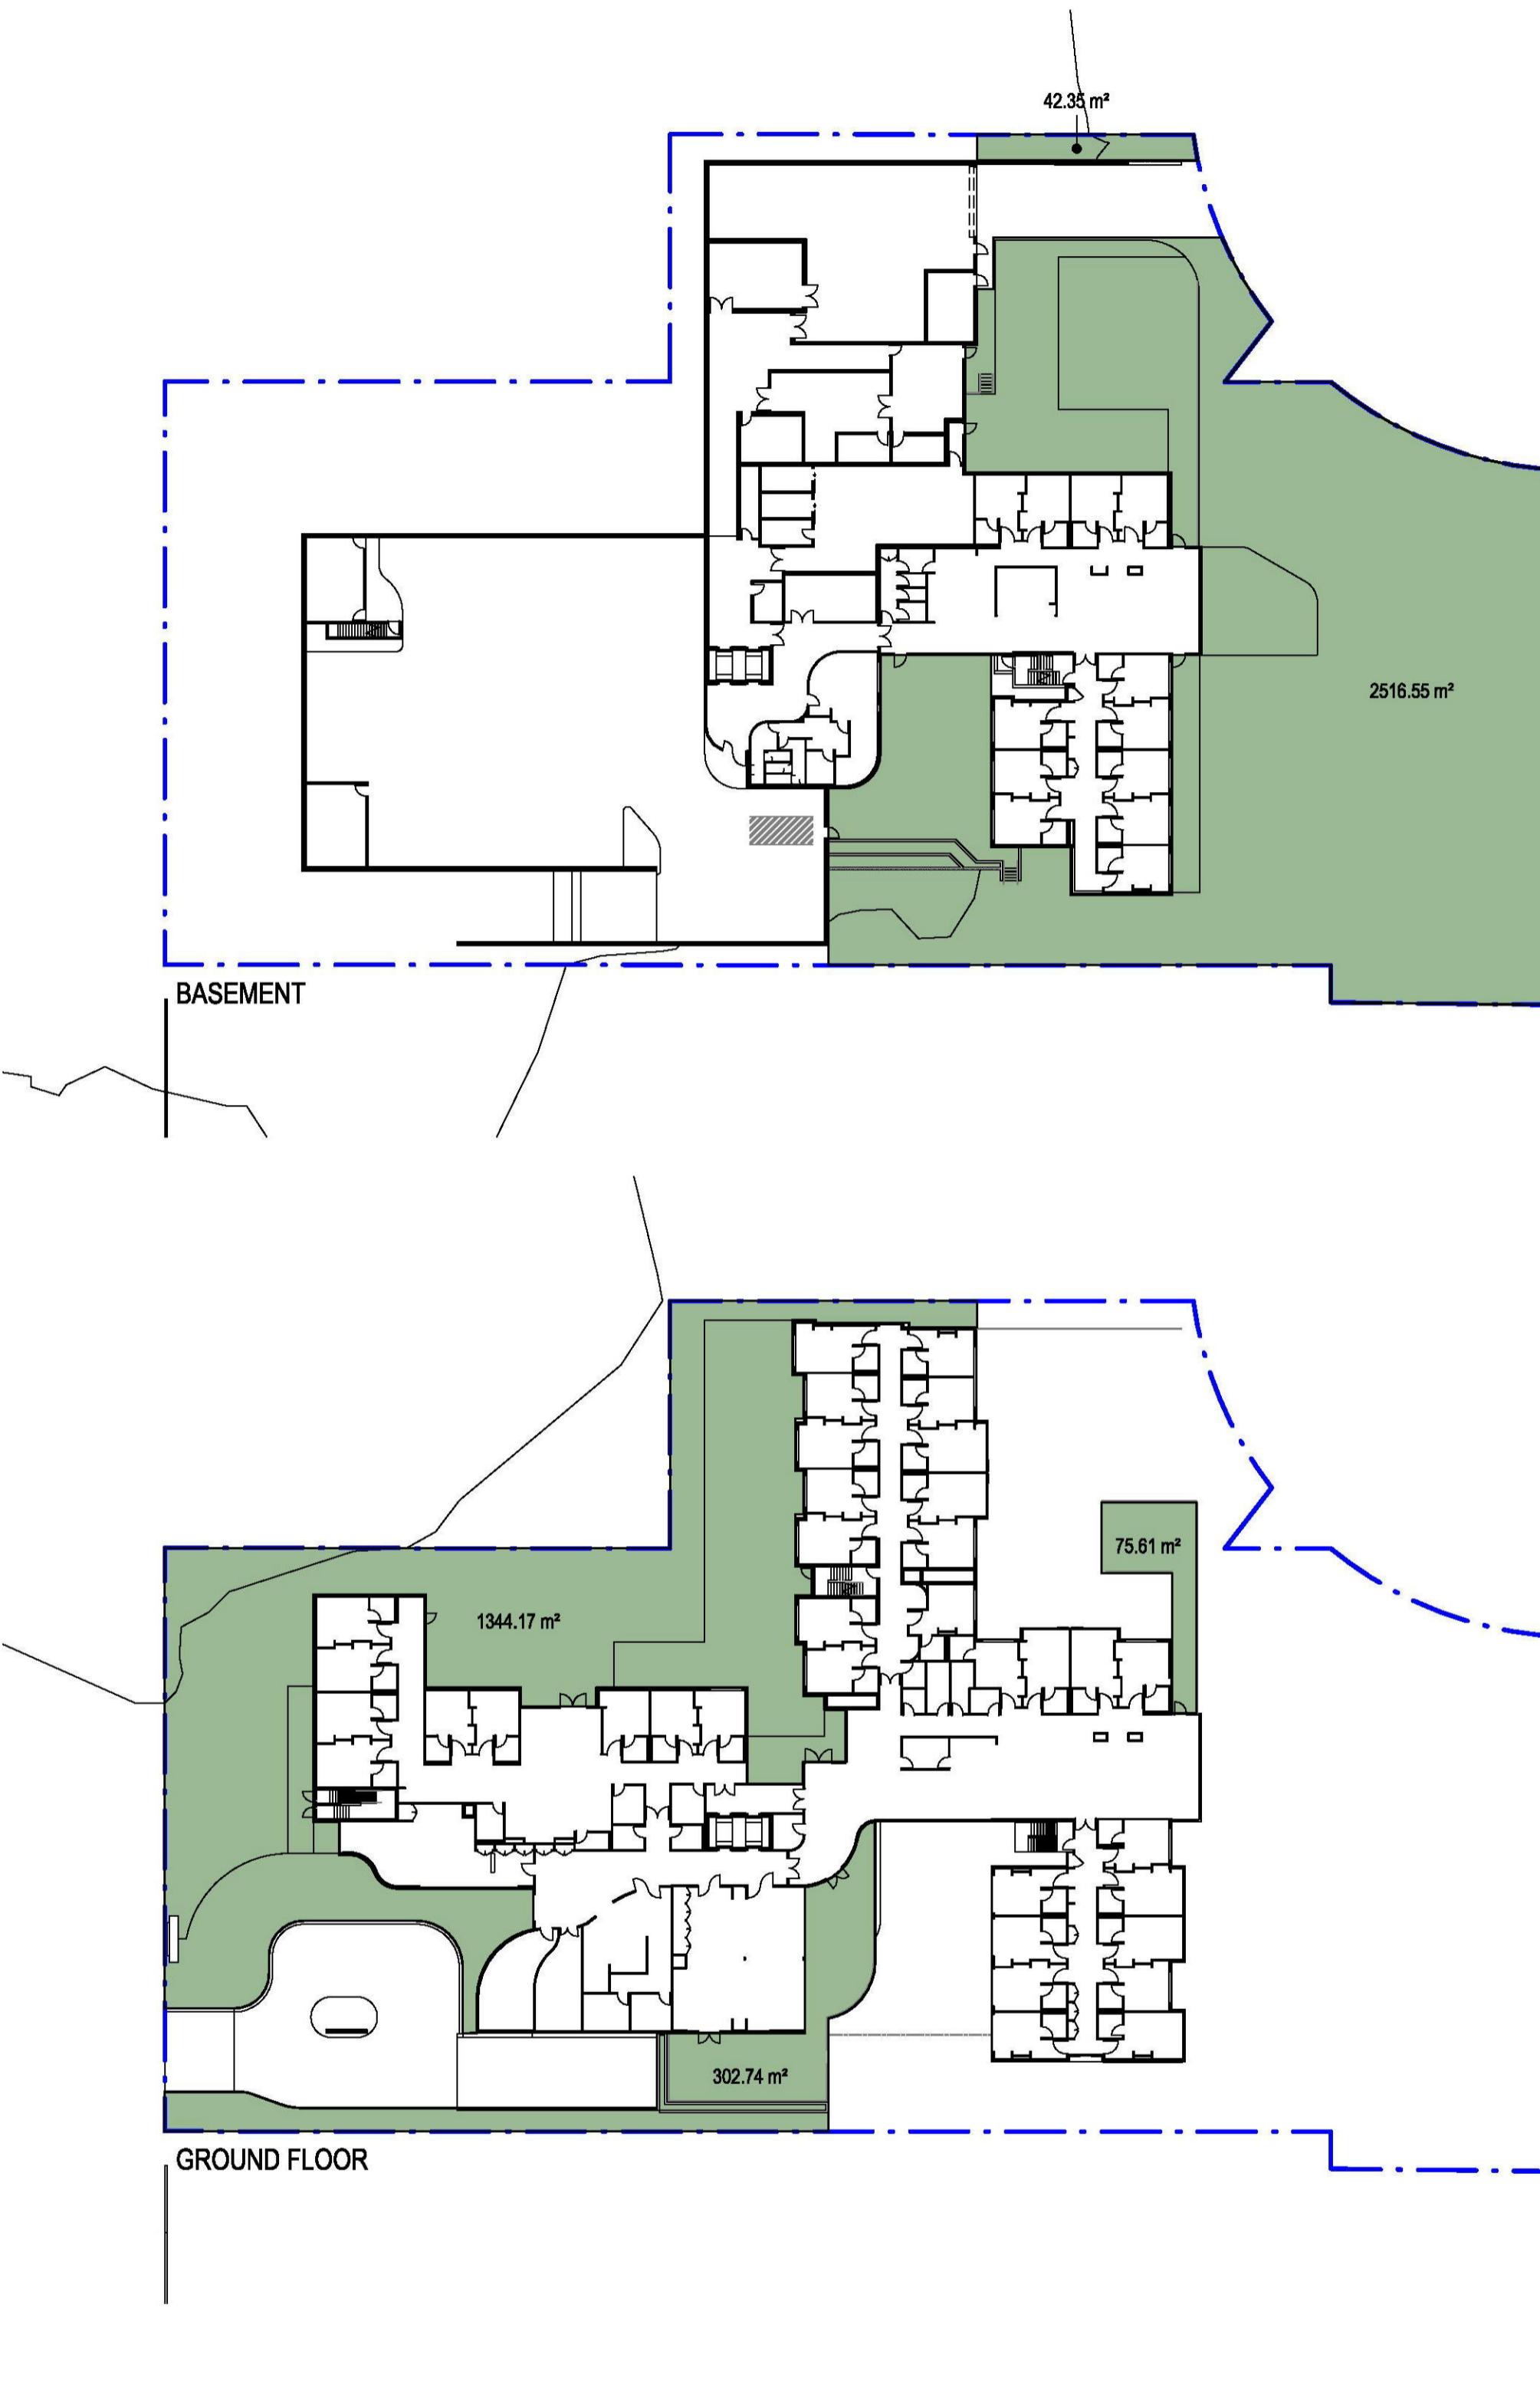
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GFA DIAGRAMS
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23.09.2019
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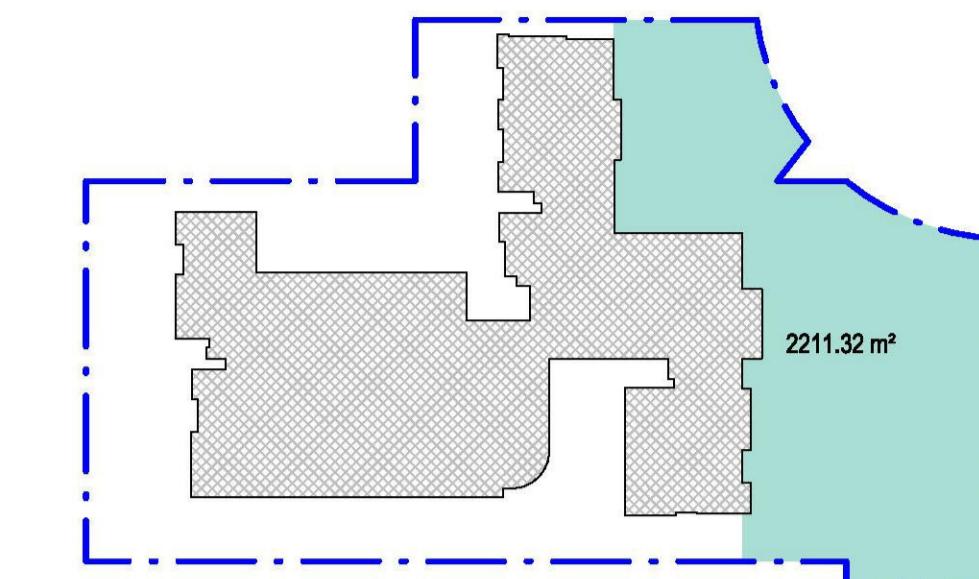
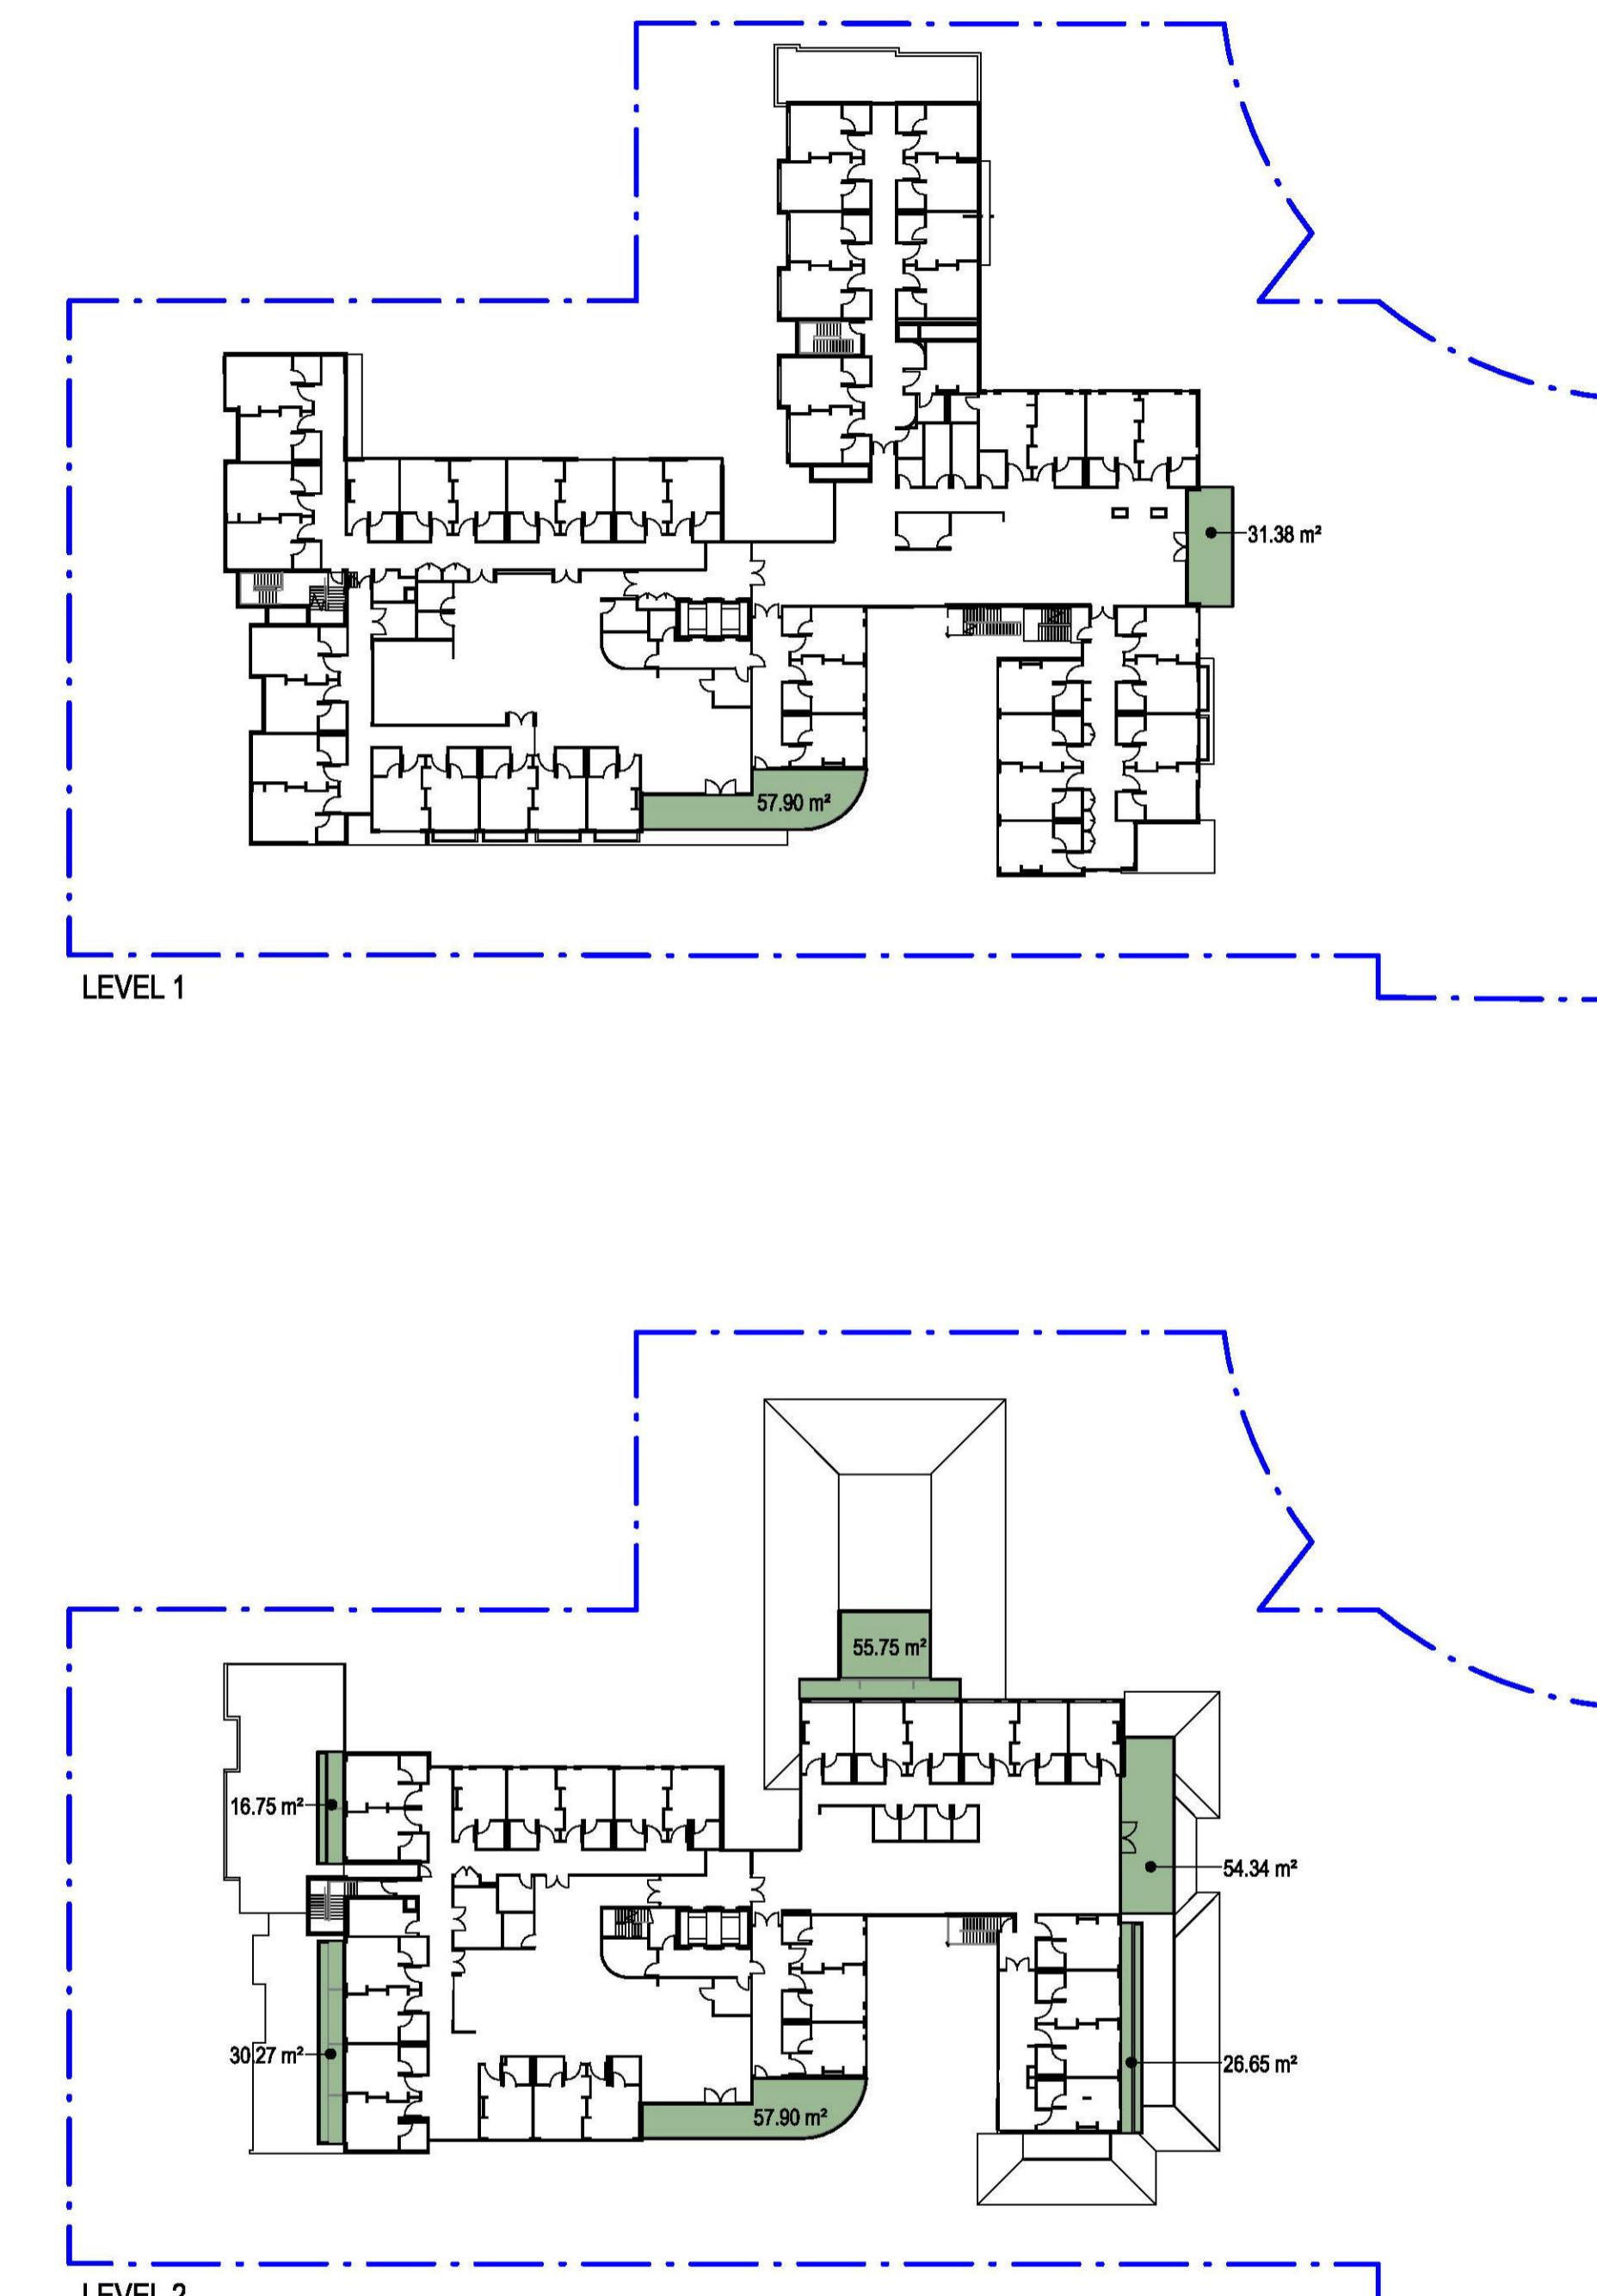
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LANDSCAPE AREA CALCULATION	
LEVEL	AREA
BASEMENT	2559 m ²
GND FLOOR	1723 m ²
LVL 1	89 m ²
LVL 2	242 m ²
TOTAL LANDSCAPE AREA	4612 m ²
LANDSCAPED AREA PER BED	38.4m ²

DEFINITION OF LANDSCAPED AREA:
Landscaped Area means that part of the site area that is not occupied by any building and includes so much of that part as is used or to be used for rainwater tanks, swimming pools or open-air recreation facilities, but does not include so much of that part as is used or to be used for driveways or parking areas.

State Environmental Planning Policy (Housing for Seniors or People with a Disability) 2004

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LANDSCAPE AREA CALCULATION
1:500 @ A1 23.09.2019
rev. A


RECREATIONAL AND LANDSCAPED SPACES

The proposed development is dominated by multiple courtyards, outdoor terraces and recreational spaces. This works directly in proportion to the extensive setbacks that the development offers.

While most landscaped spaces can be accessed by residents, the facility will include community gardens to the Watton Road frontage to allow for some additional interaction with the community. The cafe opens onto the Murray Farm Road frontage, thus increasing the building's interaction with the public domain. The cafe also utilises the landscaped area for outdoor seating and is integrated with a children's play area.

The proposed facility retains major trees, and the proposed landscaping includes additional trees and vegetation around the site, thus complementing the existing nature of the precinct. The planting is in sympathy with the existing streetscape planting.

The overall landscape garden area works out to be approx. 38M² per resident which is well in excess of the minimum 25M² required under SEPP Seniors (HSPD) 2004, and much of this is also in areas that can benefit surrounding properties.

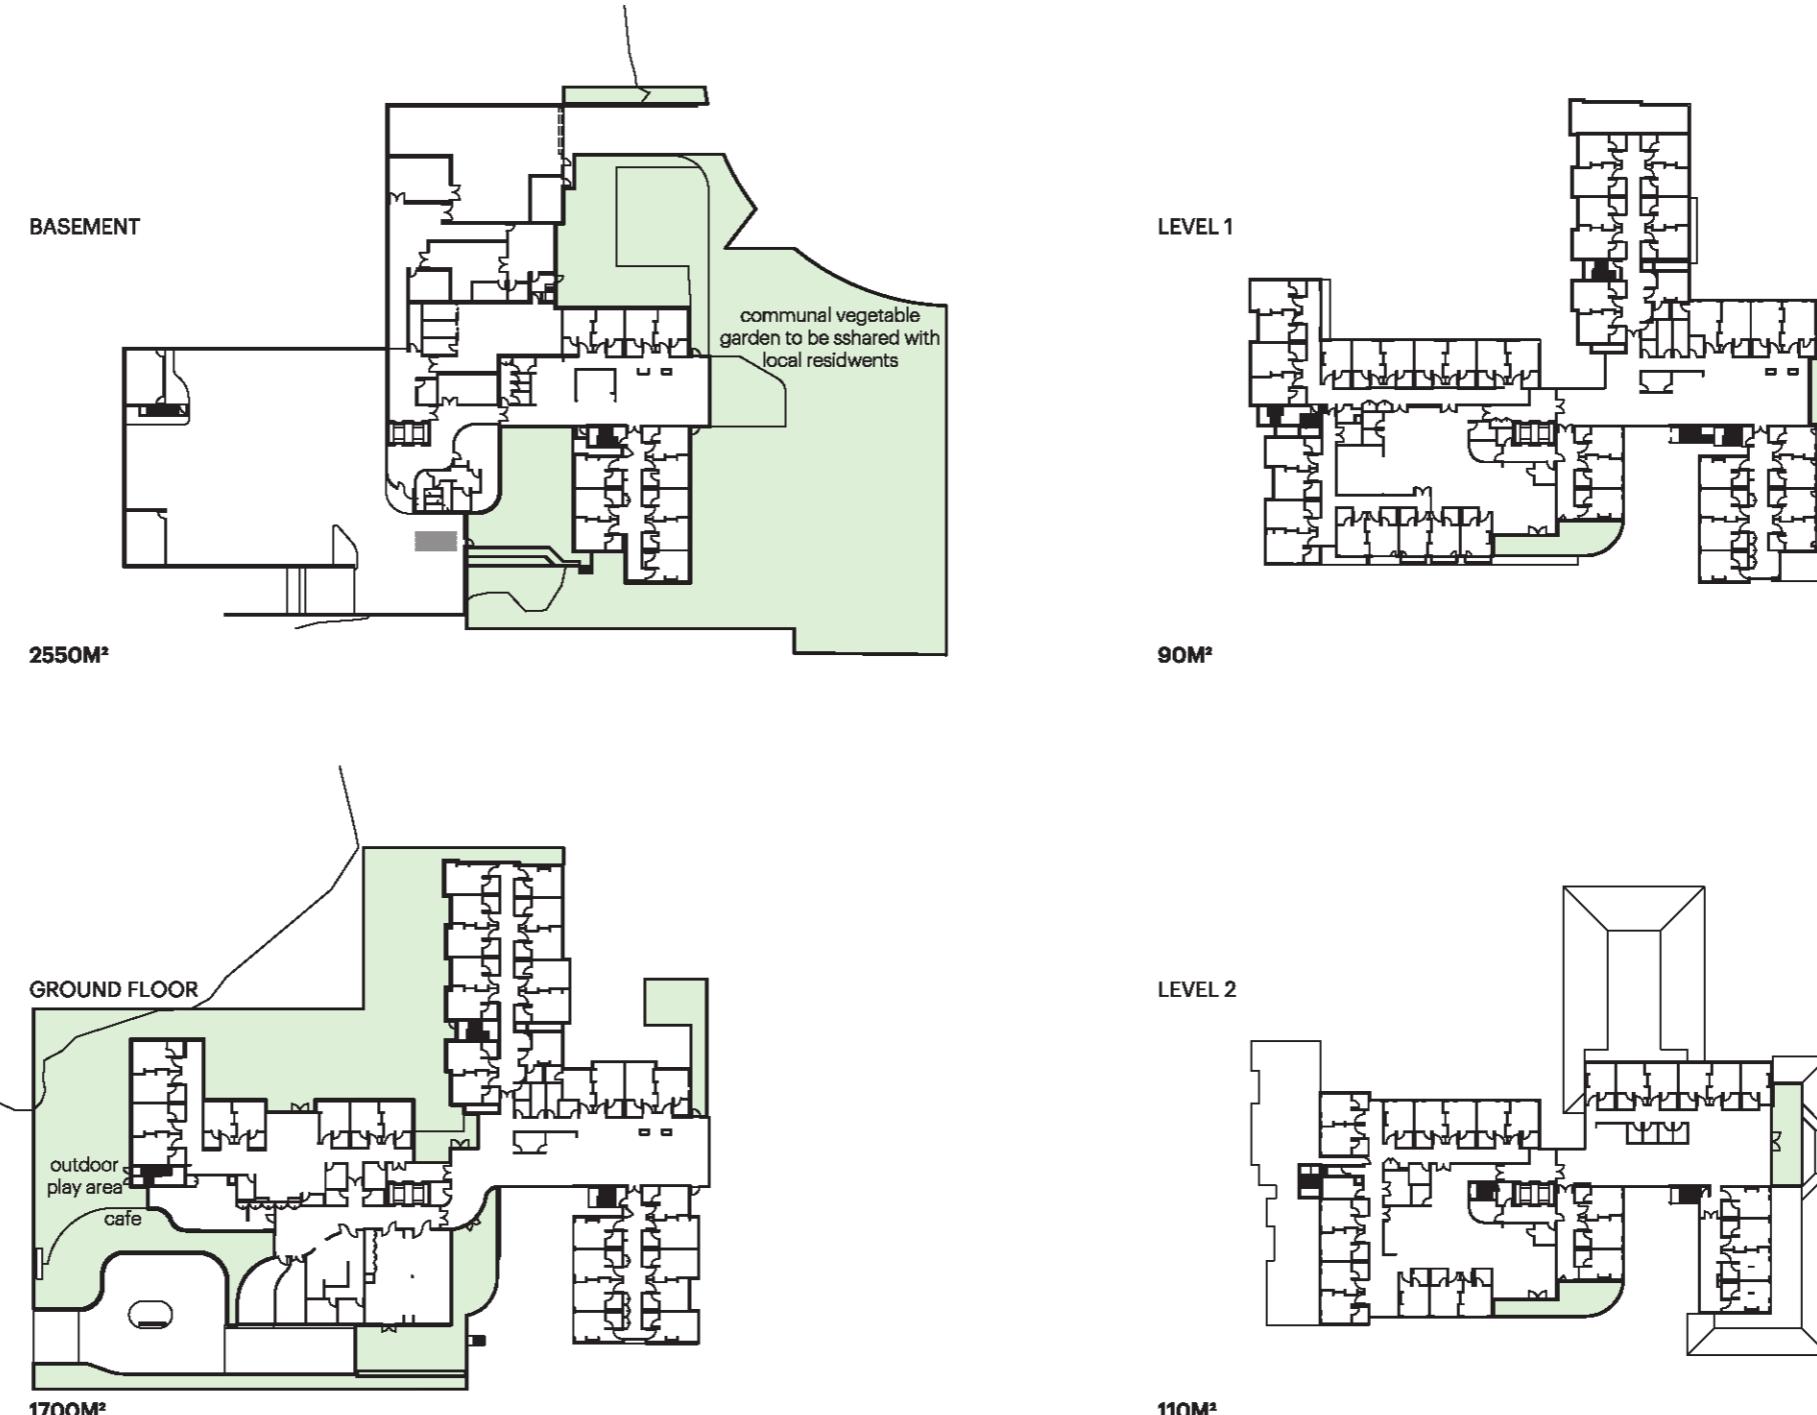

RESIDENTS PER HOUSEHOLD


The proposed facility is designed to provide each potential resident with ample living space, resulting a better livelihood. Each resident gets an abundance of 48M² of quality space.

Household A is primarily meant to be used as a Dementia household. The living space has a northerly aspect and most rooms are located to have a landscaped outlook with varying foliage and vegetation.

Household B is the smallest household in the facility with 9 beds. It primarily has a western, south-western aspect to it. This household forms the "special needs unit" component of the facility. This household has single loaded corridors and access to a landscaped courtyard, thus creating a high quality outlook.


Household C has access to the Western Courtyard and outdoor terraces. **Households D and E** have access to outdoor terraces, and will have views to landscaped courtyards and existing tree foliage. Most rooms will receive daylight and filtered sun throughout most of the day.

Households F and G are highly efficient in spite of having single loaded corridors with most rooms opening onto either a living space or balcony.

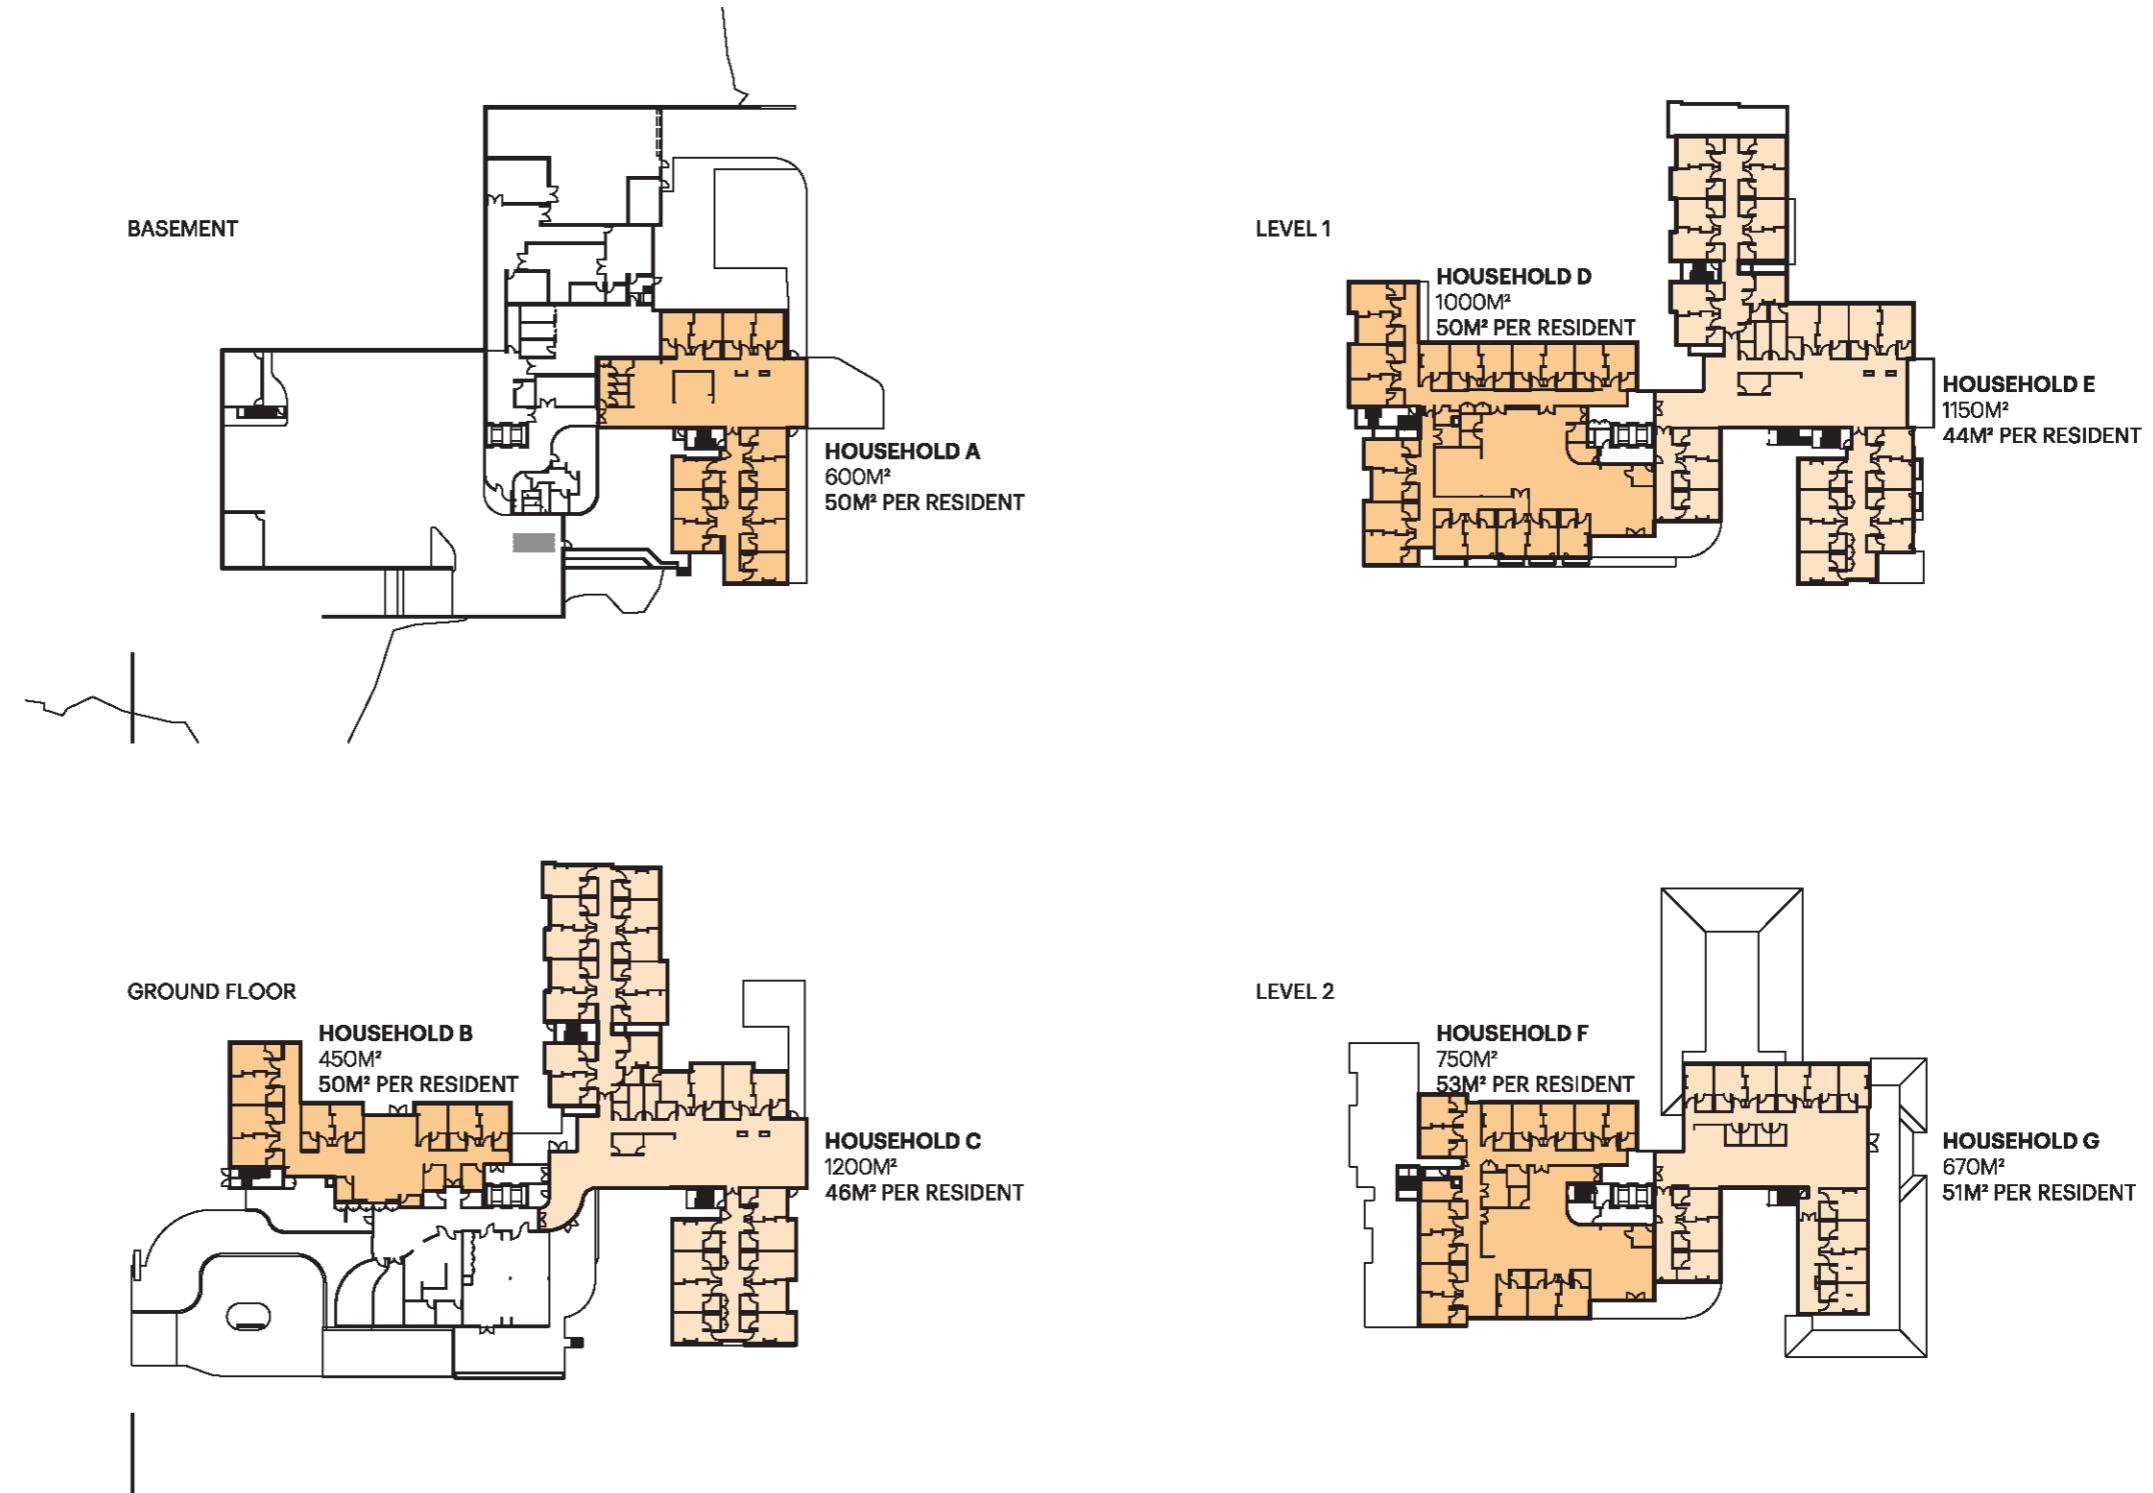

SOCIAL SPACE PROVISION

The facility has a wide and dispersed range of social spaces with an average of 16M² of social space provided for each of the residents. This excludes other sitting nooks in corridors, terraces and other recreational spaces.

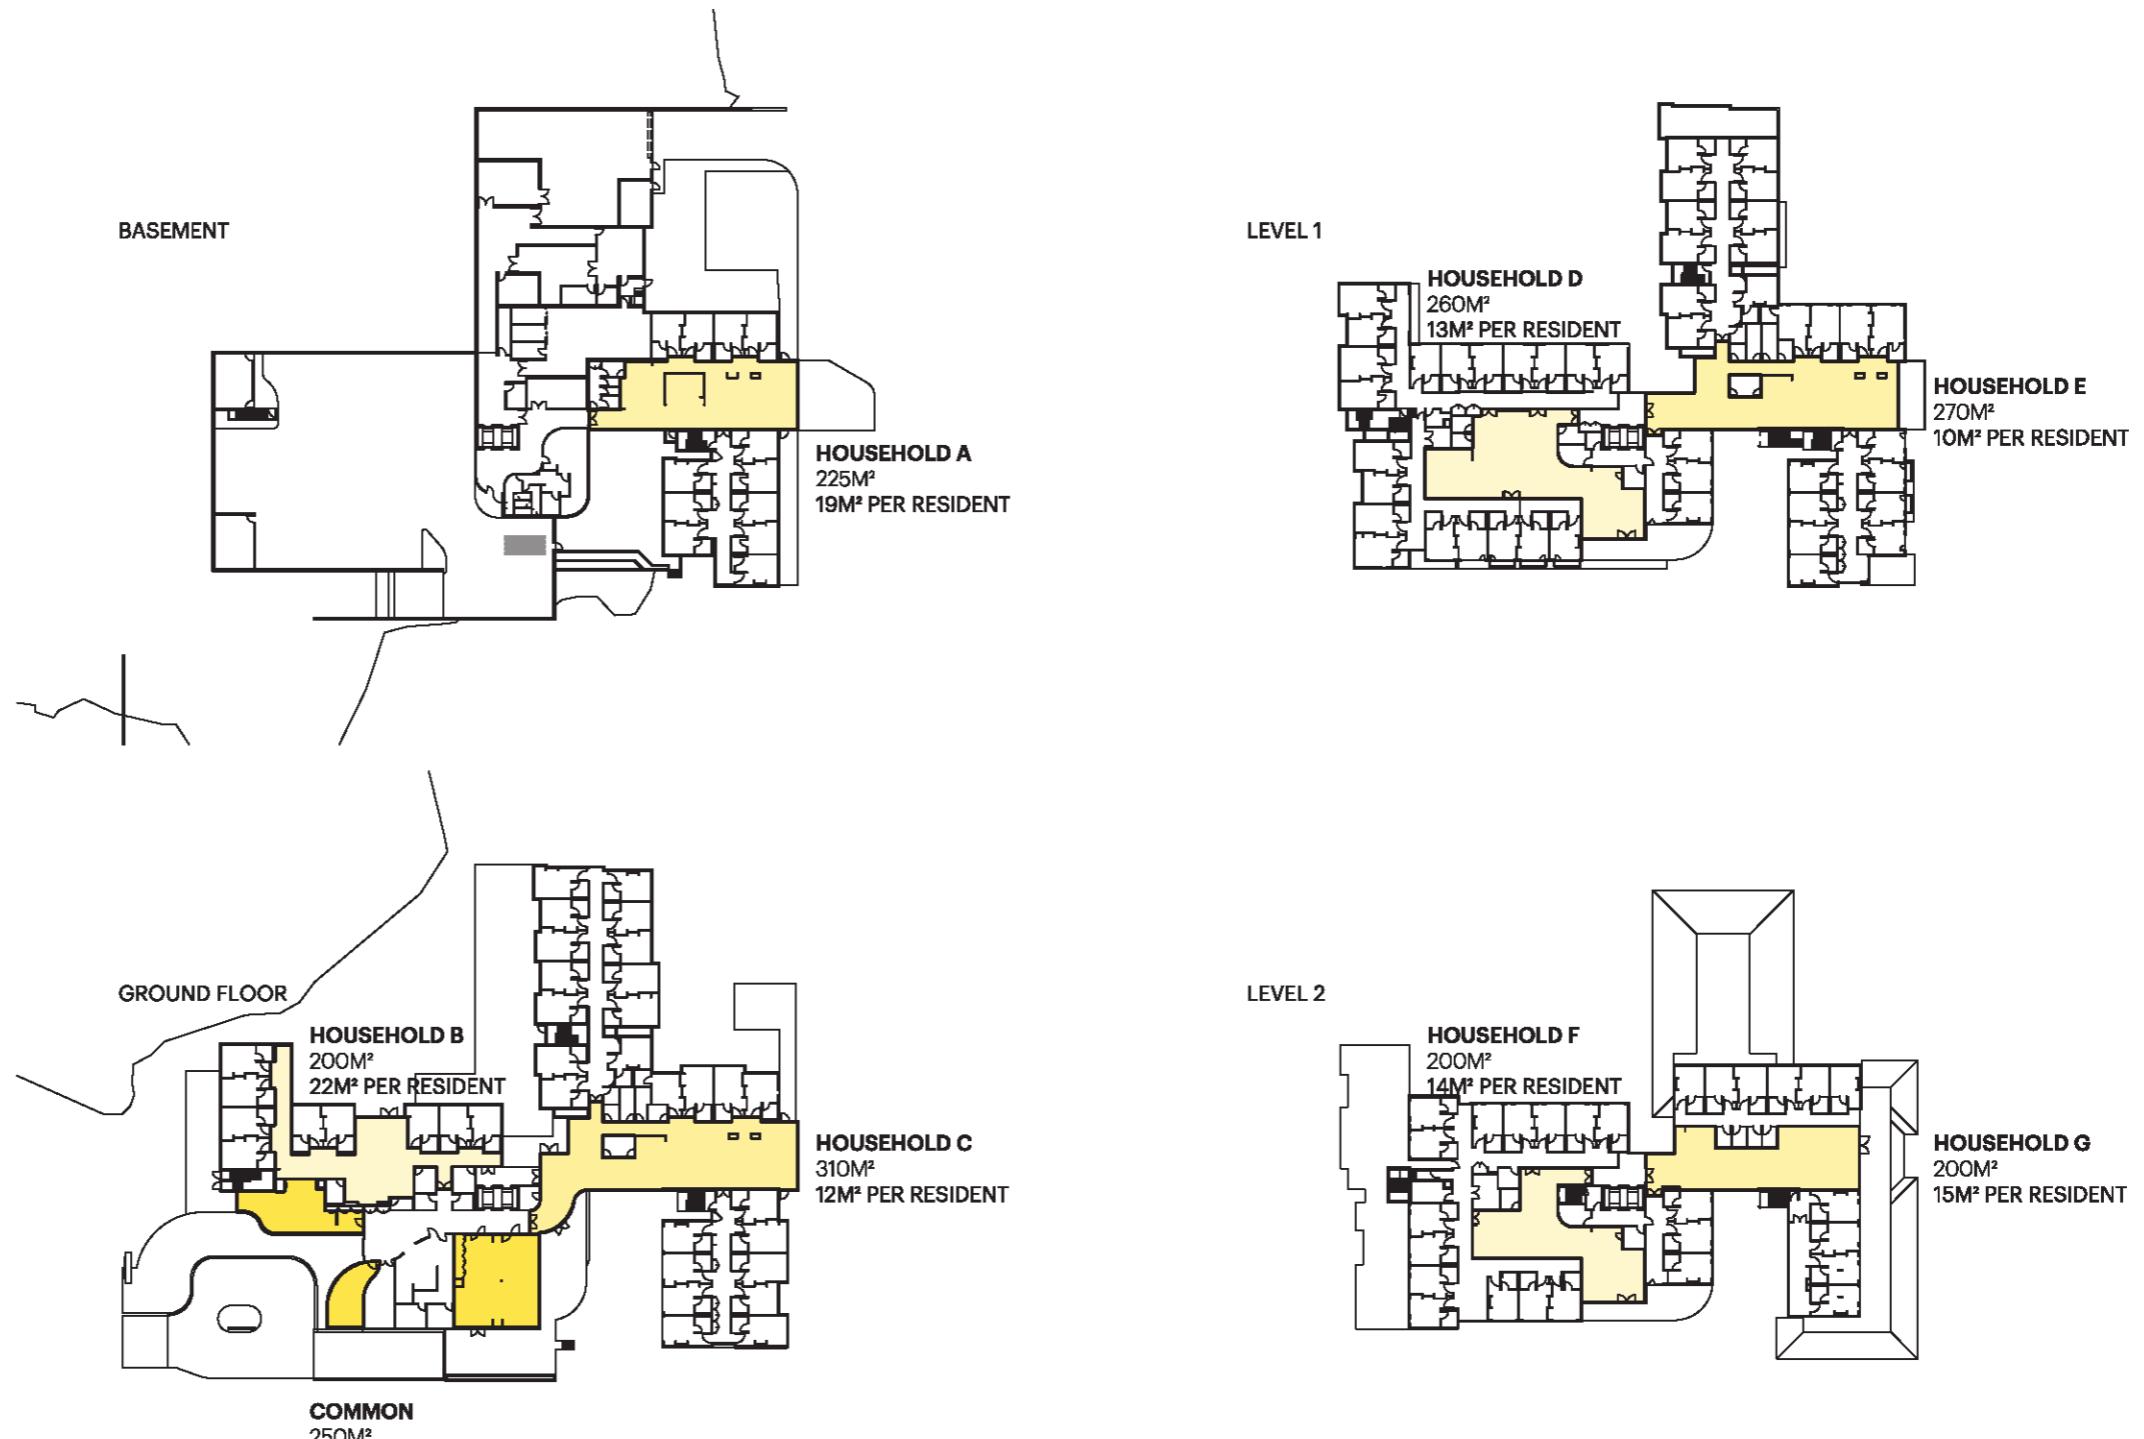


CROSS VENTILATION PLAN

Creating a diversity of options for the residents is critical to the design. This proposal offers small and larger sitting spots around each neighbourhood so there are various options including places in the sun, that are sheltered and amongst the landscape.

This includes feeling the wind and hearing the breeze through the trees – the terraces, courtyard gardens and garden space we have created are designed to enable staff, residents and visitors' places that are secure and intimate.

Sustainability aspects of developing a building that can operate in a mixed mode has been an important part of the design – that is to facilitate cross ventilation through the building.

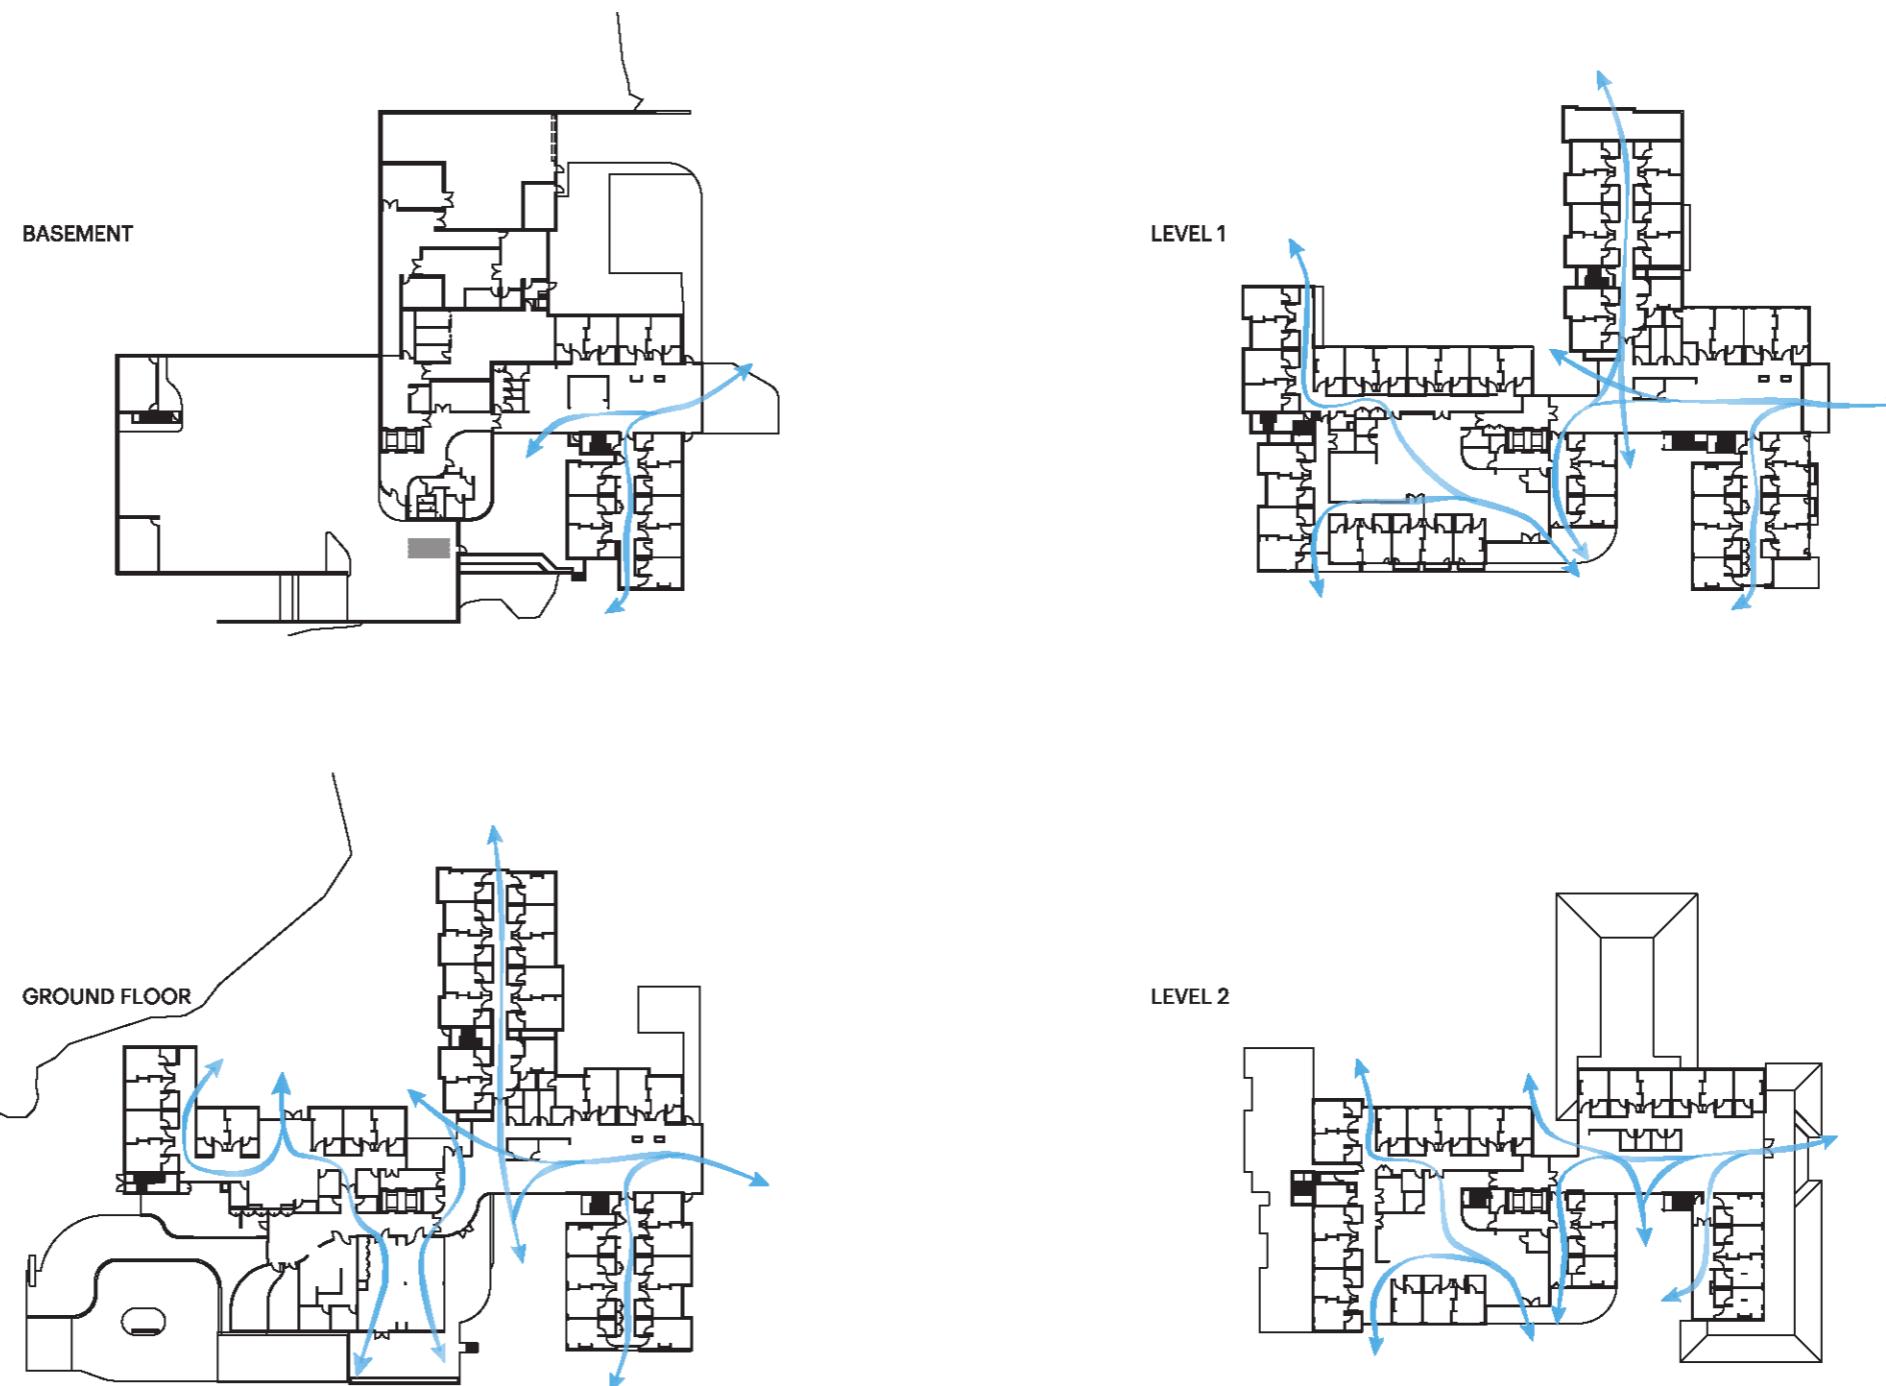


BOUNDARY CONDITIONS

The relationship of the building to the immediate neighbouring residential structure and street frontages is demonstrated through these sections.

The proposed built form in all instances defers to the context whilst enabling view sharing and the preservation of the existing canopy trees.

These very large specimens are visible from many vantage points in the surrounding suburb.



The building sits in different planes along Murray Farm Road in order to reduce the perceived bulk of the built form.

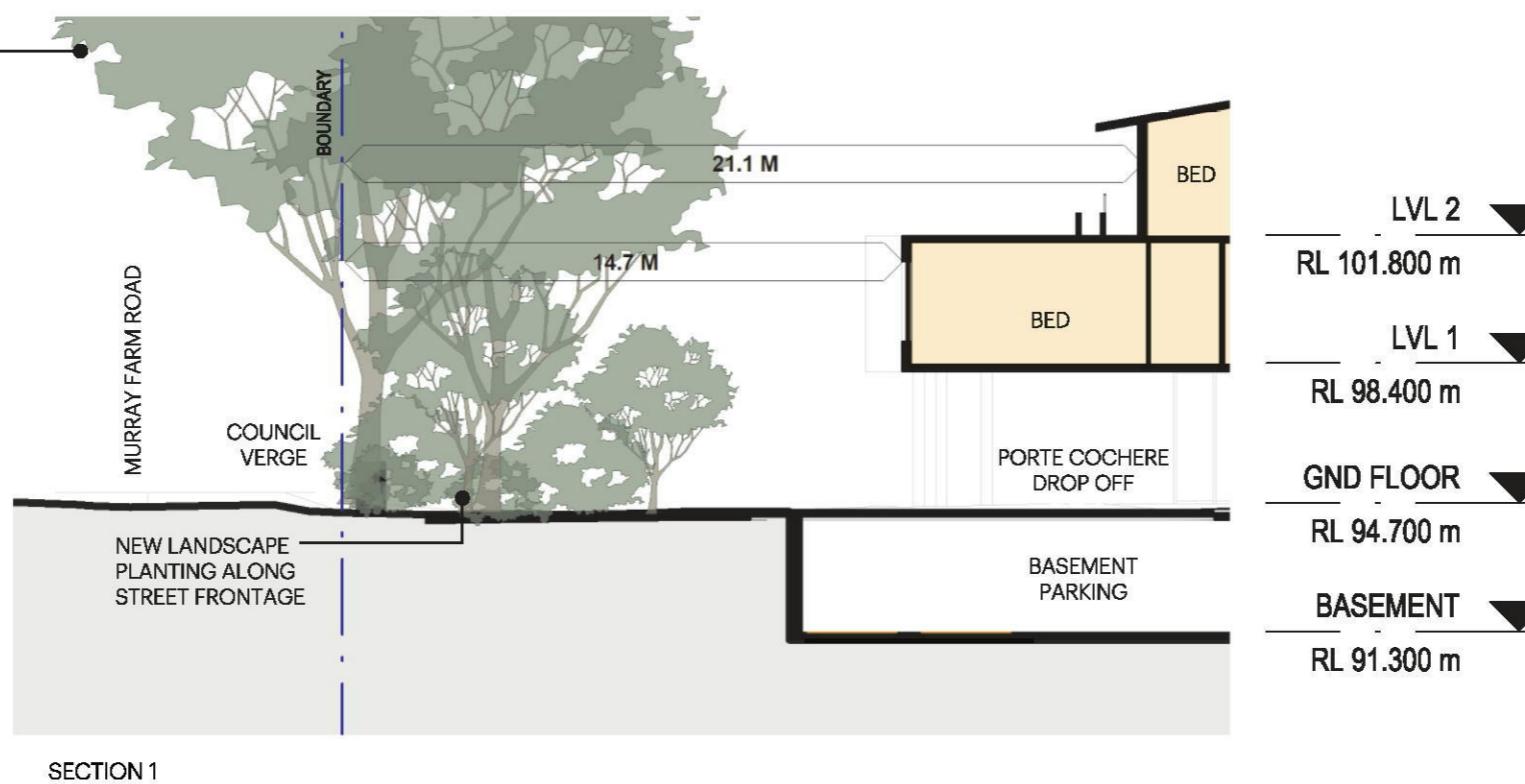

The proposed building has a setback of 11.8M from the property boundary at the worst point along the Murray Farm Road frontage. The third floor is setback by over 20 meters, thus making it virtually unseen from Murray Farm Road. This helps to make the building look like a two-storey component along Murray Farm Road.

The facade treatment further helps reduce the long facade and breaks the building up into smaller, house-like modules.


The existing and proposed landscaping further softens the built component and helps harmonize the building with the existing streetscape.

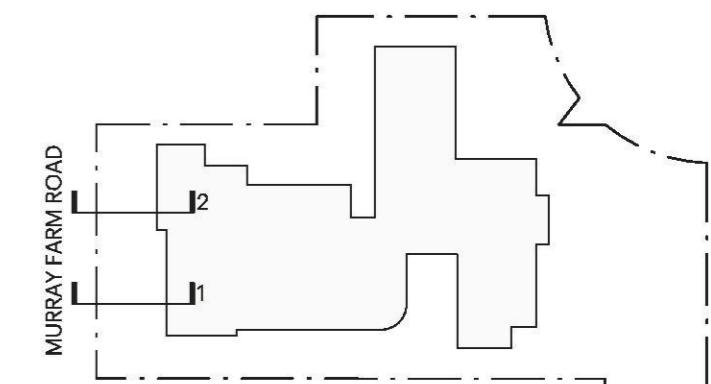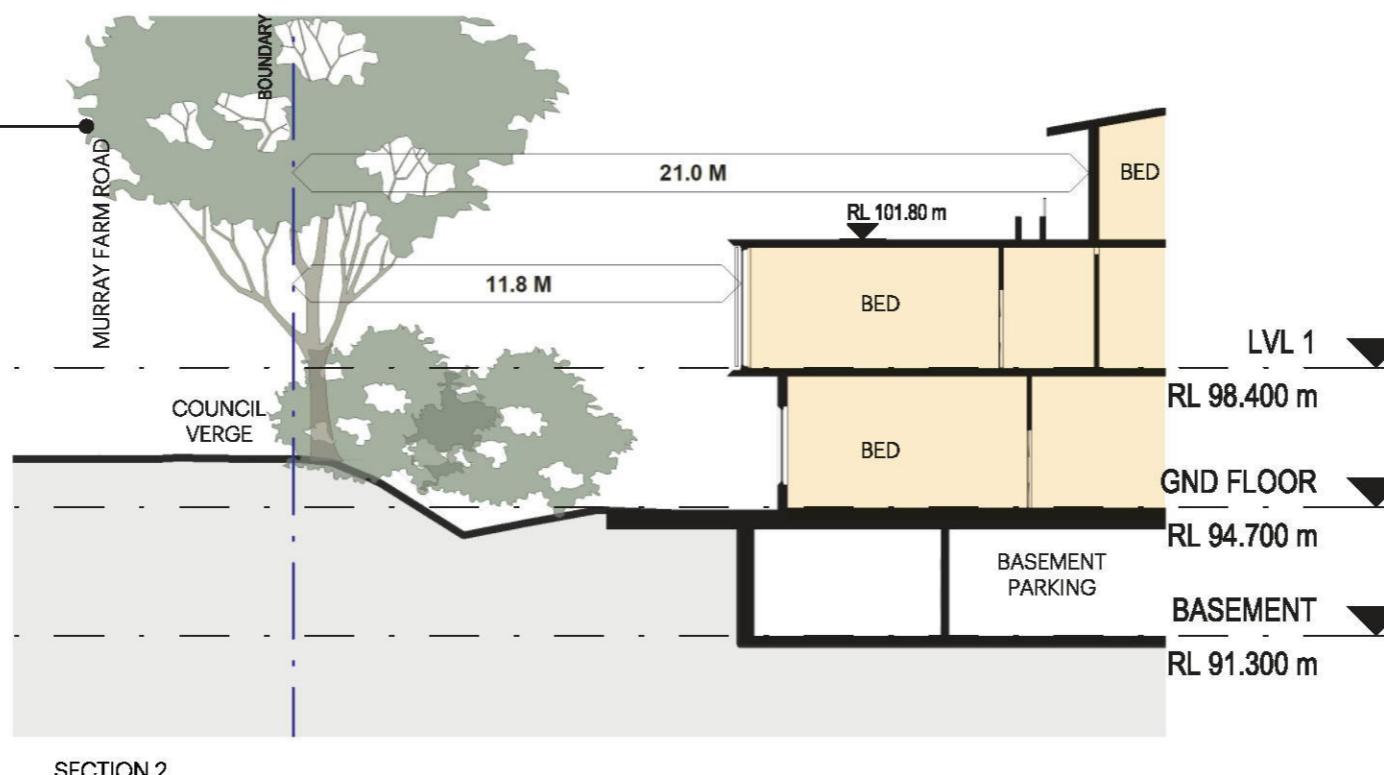

BOUNDARY CONDITIONS

The two-storey element fits into context and relates directly to the built form of 49 Murray Farm Road. The proposed landscape features create an adequate privacy buffer thus mitigating any potential overlooking. The extensive 32+ meter setback further contributes towards any privacy breaches to the neighbouring property.


The roof design is an important element in the overall composition and design of the proposed building. The proposed hip roof is in character with the adjacent dwellings, thus keeping in-line with the adjacent built character. The soffit overhangs and the eaves are important characters that define the roof pitch and increase the overall bulk of the building, but greatly help to make the building sit in place with the existing context.

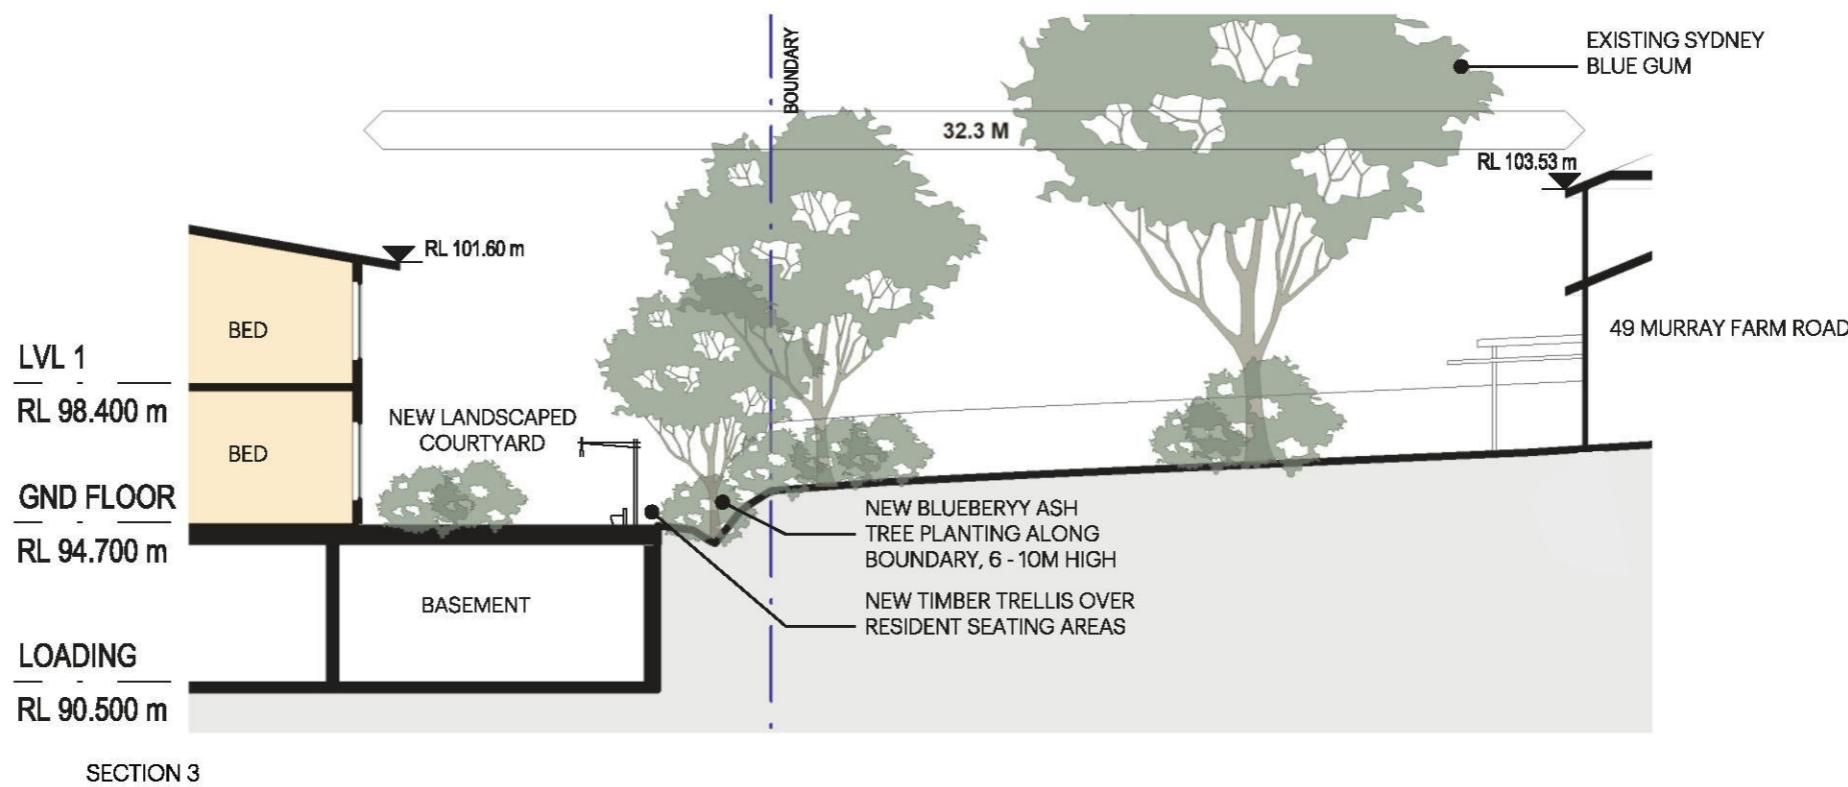

The relationship to 49 Murray Farm Road and the building separation is in line with the existing local character. Most existing dwellings sit around 1 meter away from the side boundaries.

The proposed built form, two storey component, creates a sensible approach to the neighbouring property. The specific part of the proposed building has no windows to avoid any breaches to visual and acoustic privacy to the neighbouring property.

The proposed planting will act as a buffer zone between the two properties.

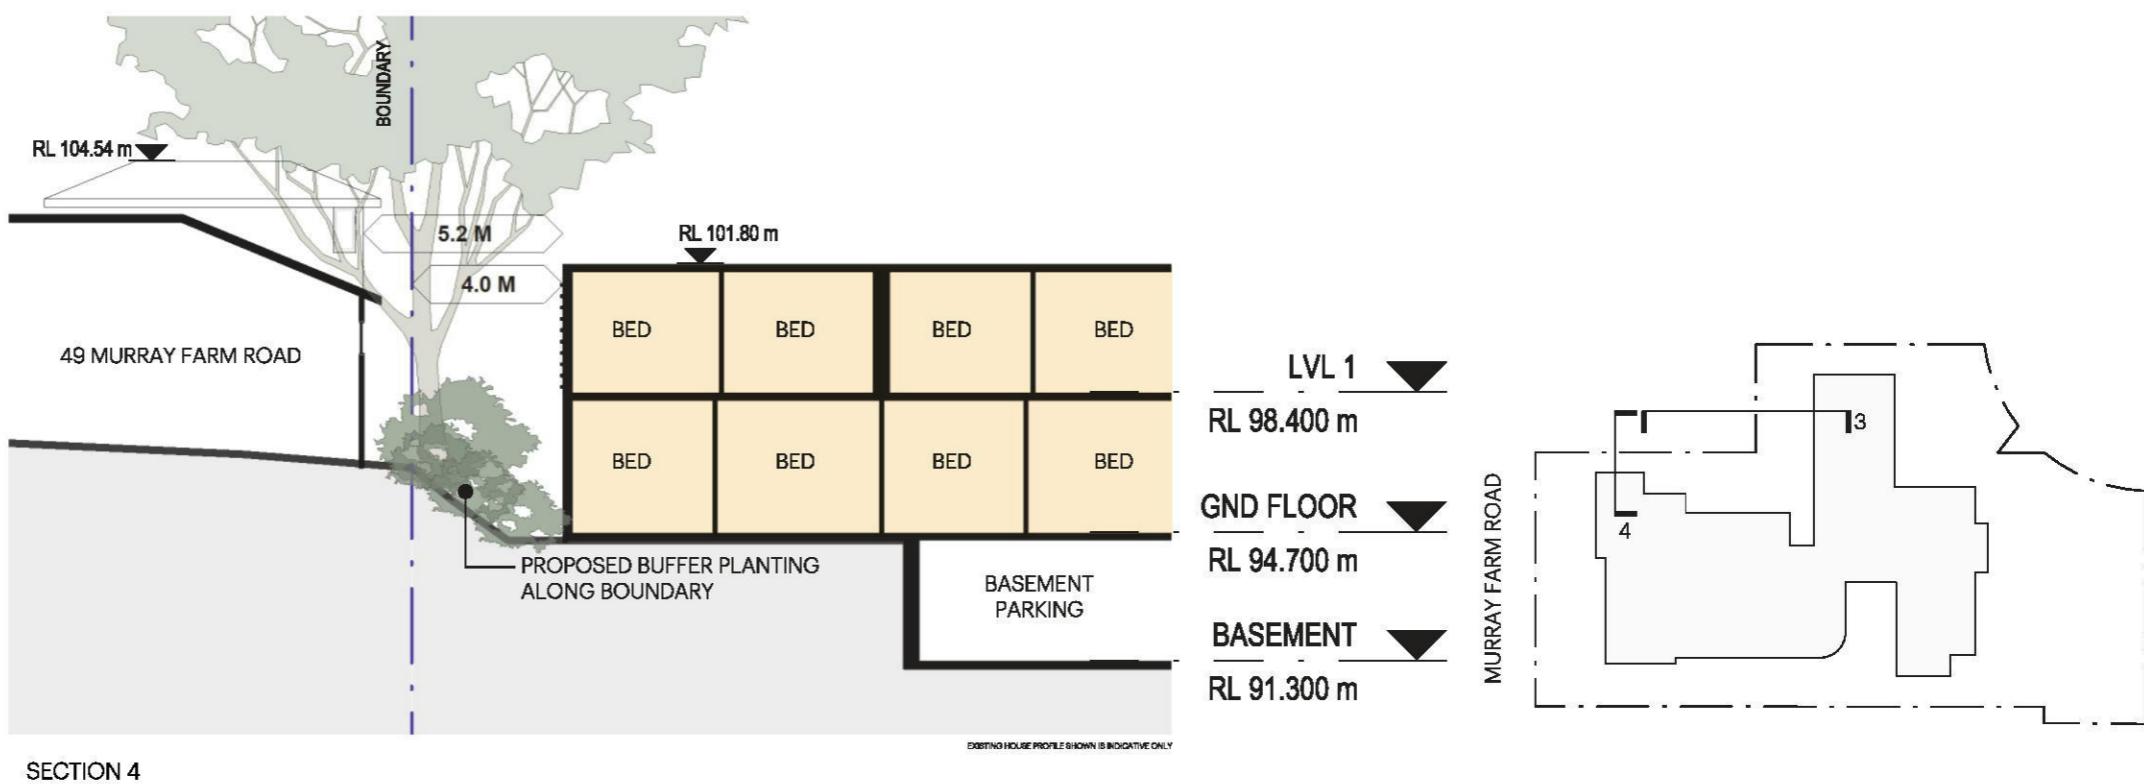


BOUNDARY CONDITIONS

The existing property at 13 Watton Road sits close to 11 Watton Road, the neighbouring property to the proposed facility.



The stepped transition along the side boundary with 11 Watton Road helps reduce the bulk and scale along the boundary. Furthermore, the eaves and the hip roof help give the proposed elevation a residential look.

The two-storey component is keeping in line with the newer dwellings being built around the precinct. Additionally, with planting and trees, the amenity and privacy to 11 Watton Road will not be compromised.

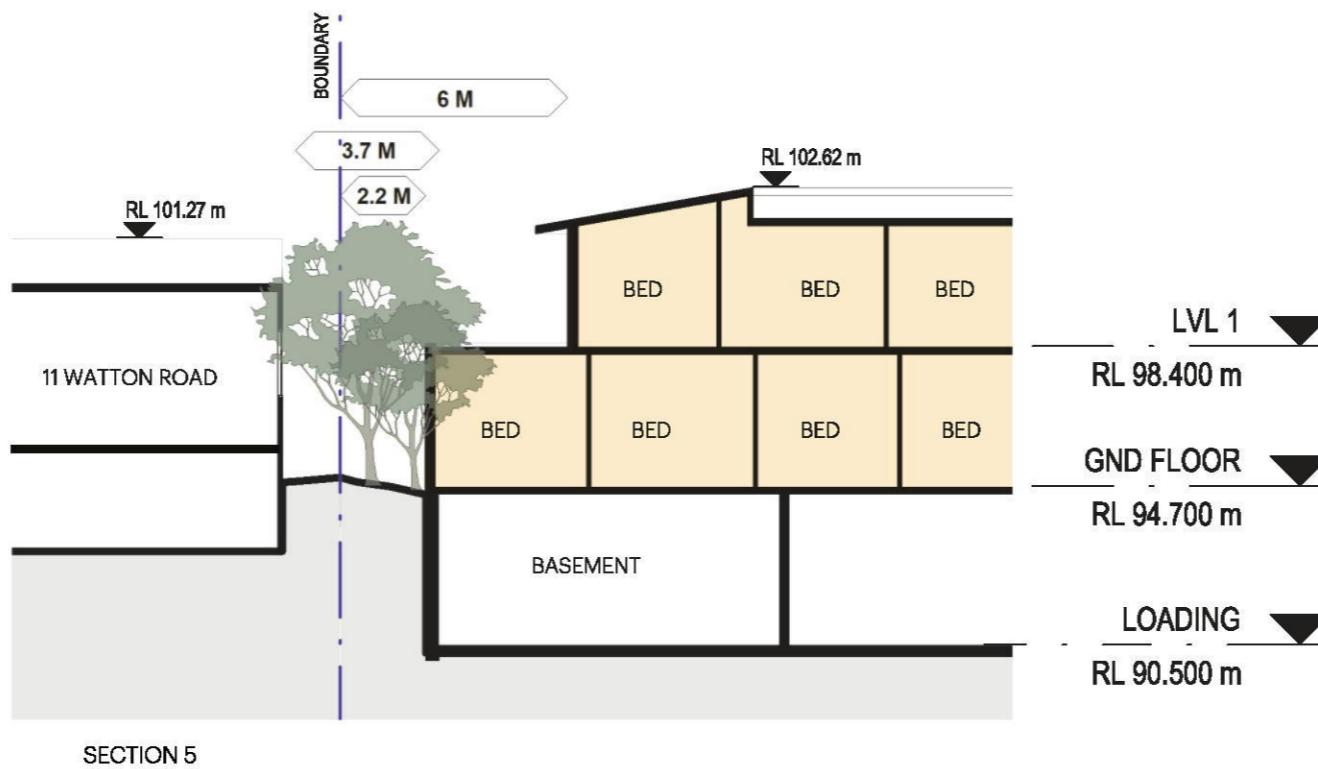

The existing Sydney Blue Gums create a natural buffer along the Watton Road street frontage. The substantial setbacks to Watton Road greatly help reduce the bulk and scale of the building.


Both the street frontages to the building have been treated as front of house entries, despite the Watton Road frontage being an entry for staff only. The use of various elements over the facade for treatment help contribute towards breaking the bulk of the building. The Pergola-Trellis element over the resident courtyard creates a stepped transition from the street to the built form.

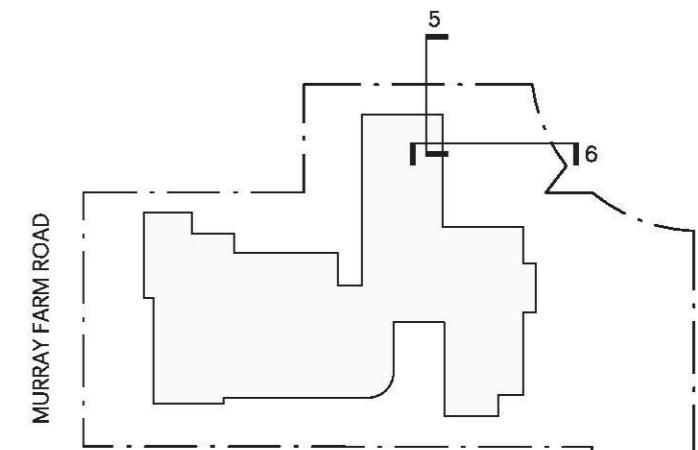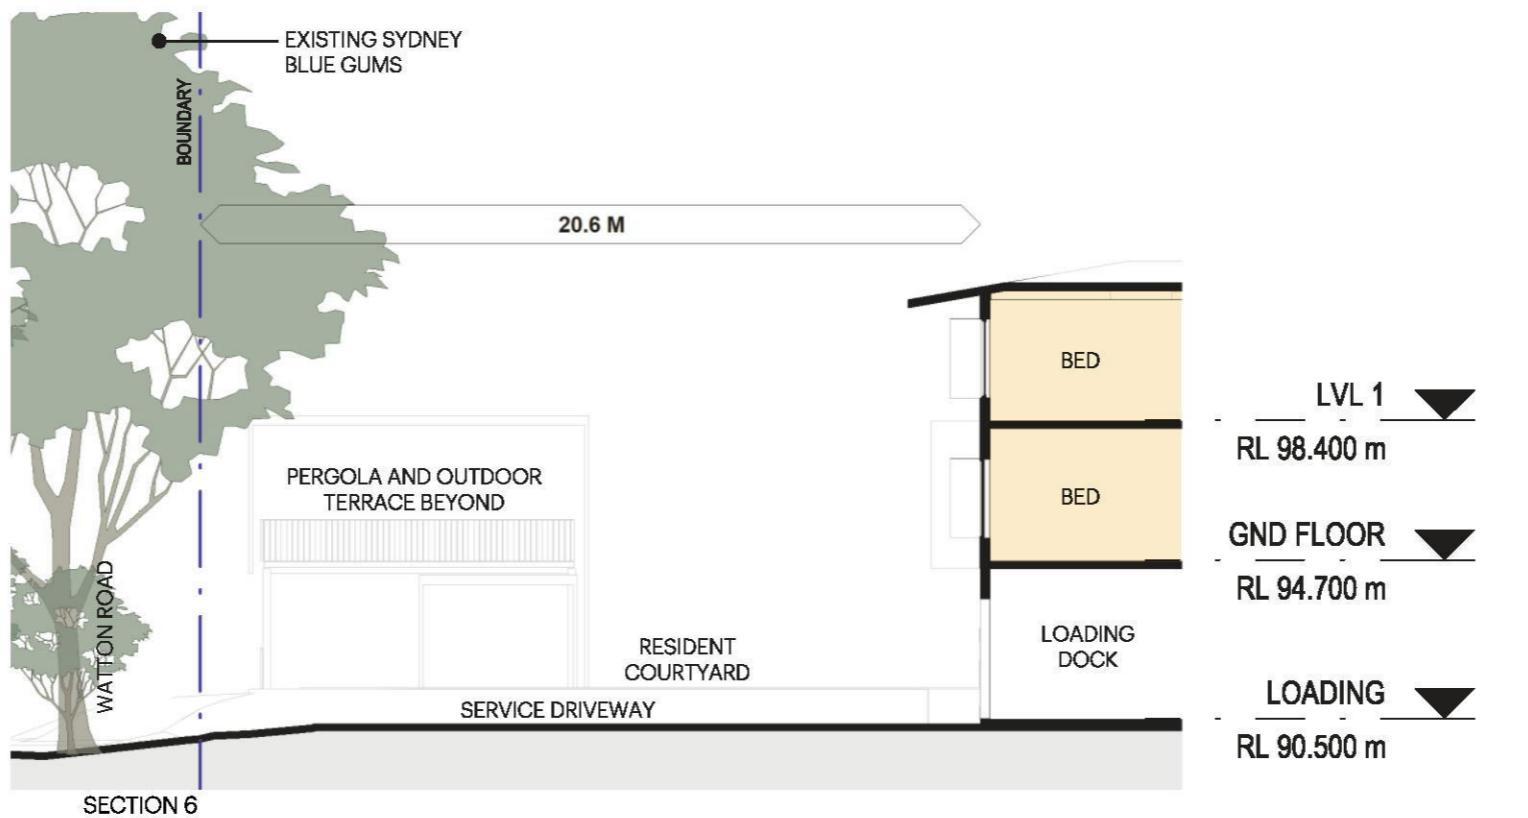



BOUNDARY CONDITIONS

The proposed new planting along the boundary and the existing Sydney Blue Gums create a visual buffer adequate for residents and neighbours. The extensive 30M+ setback and the existing trees further contribute to the buffer zone, virtually hiding the bulk of the building when seen from Watton Road.

The articulated facade and mass break the building down into smaller, residential scale components.

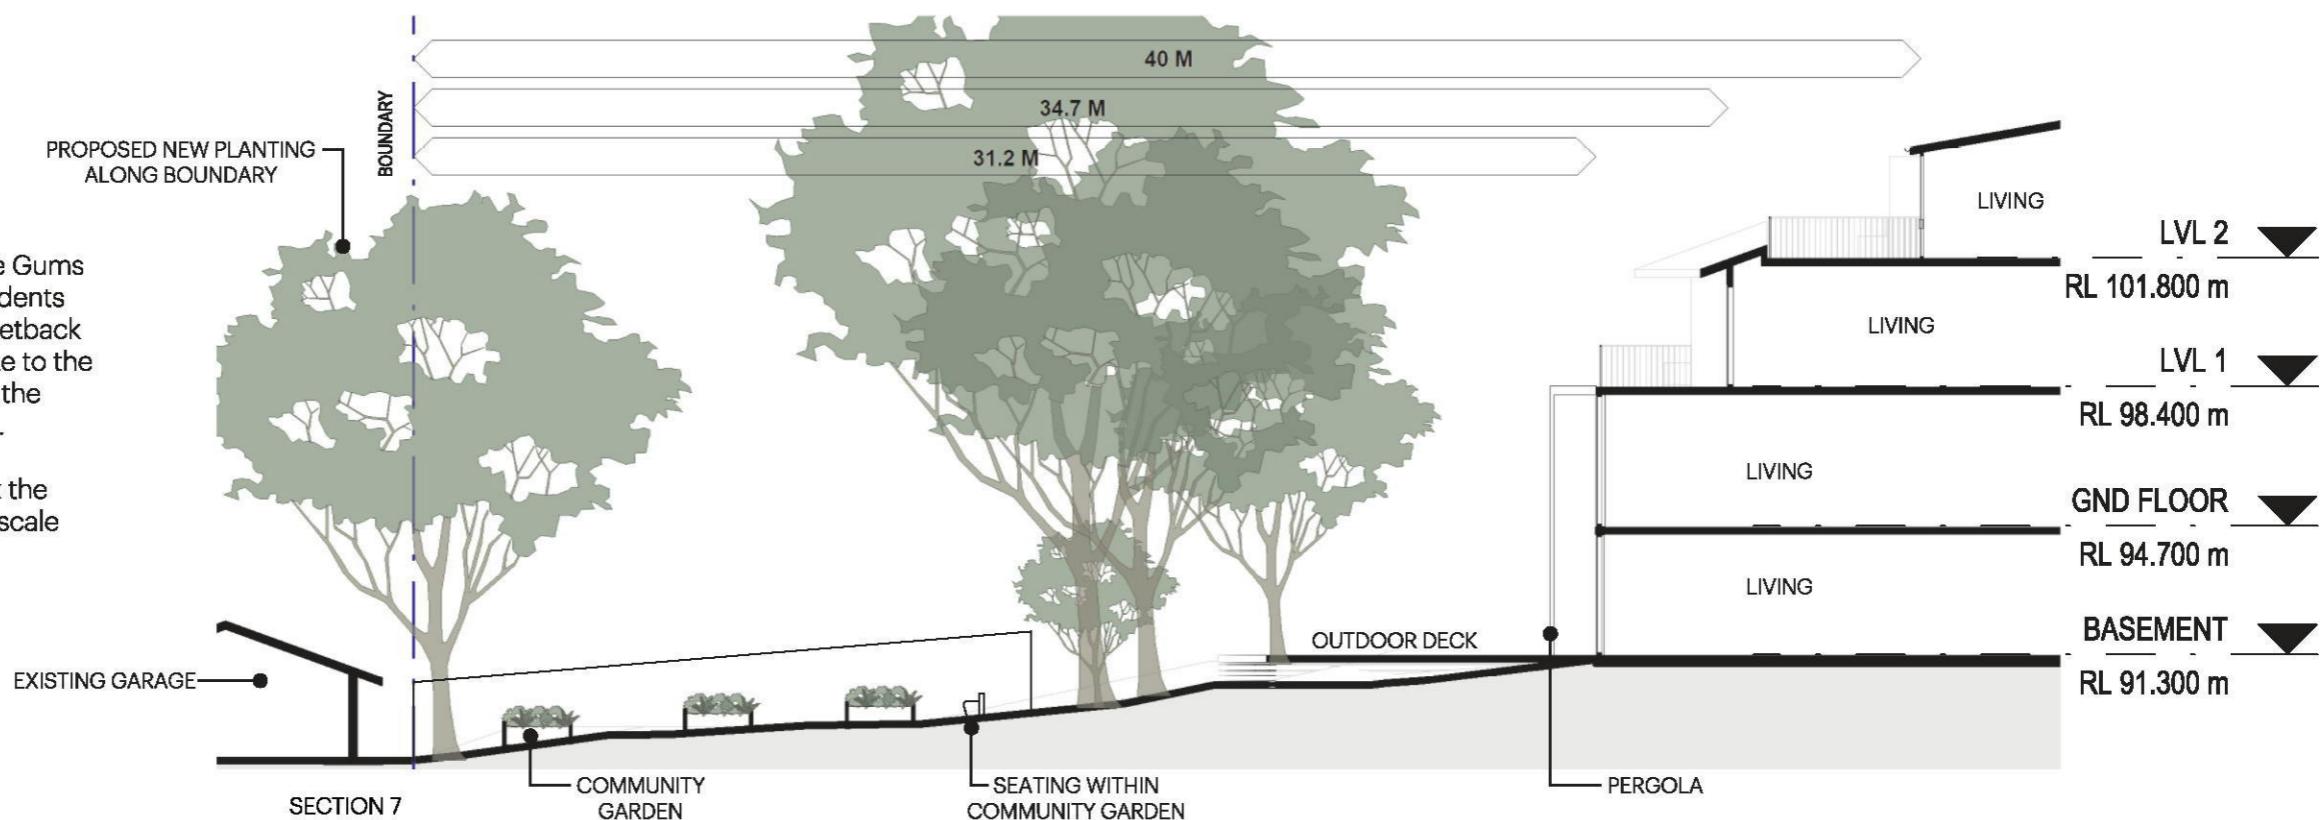

The proposed community garden brings value to the neighbours and proposed facility by allowing a space for visual and social interaction with potential for collaborative interaction between residents and neighbours.

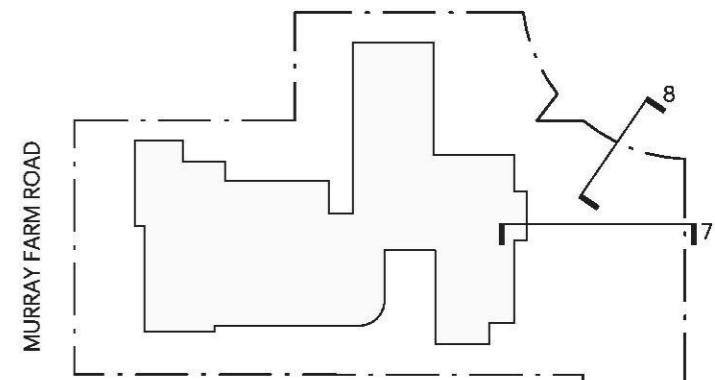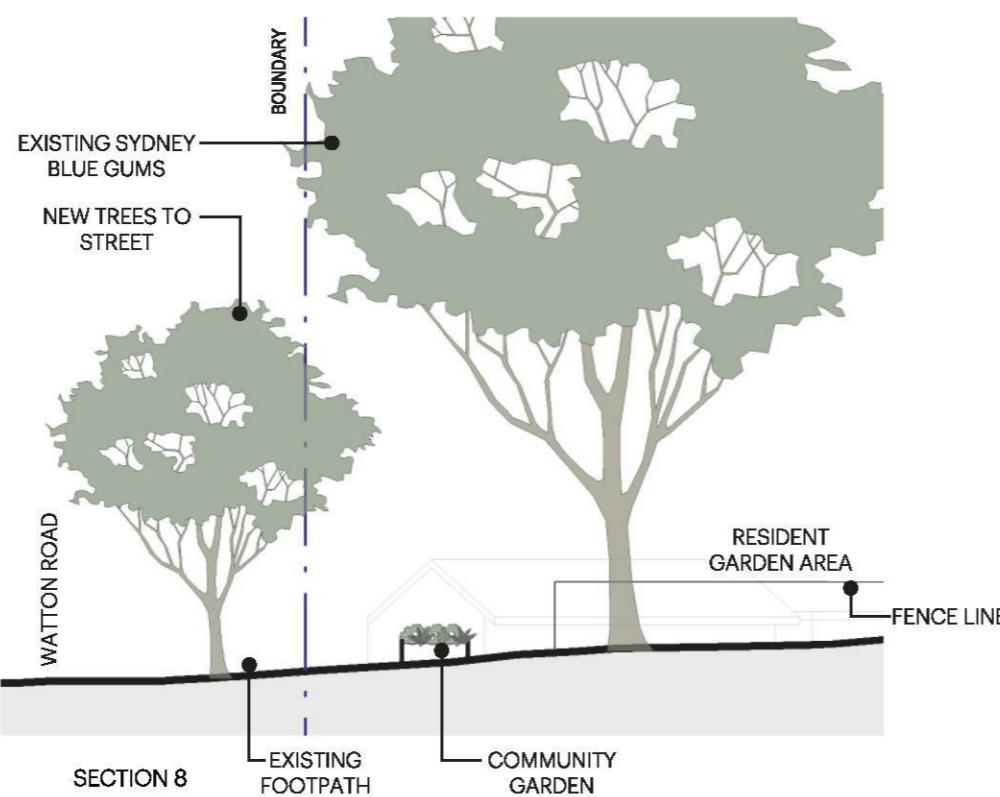




BOUNDARY CONDITIONS

The proposed development allows for a significant setback of 12 meters to 63 Oakes Road. The dense foliage of the existing Sydney Blue Gums along the boundary and the proposed planting mitigates the built form by offering a natural buffer to the adjoining property.

The built form presents itself as a two-storey component. The basement sits within a retained courtyard with banked landscaping around it. The ground floor and level 1 presents itself as a 2-storey component with the hip roof and the eaves further contributing to a residential look built form. Level 2, which is setback further, will virtually be unseen from the property boundary, thus giving this part of the building a 2-storey perception.



Abundant vegetation, existing trees, proposed landscaping and generous setbacks have been taken into consideration to minimise the impact to 41A Murray Farm Road. The private open space for 41A Murray Farm Road is towards Oakes Road rather than the property boundary, as ascertained by the visual impact analysis.



The significant and varying setbacks to the built form from the property boundary further contribute to soften the transition. The pergola over the driveway, the balustrade profile to the outdoor terraces, planter boxes to windows on level 2 and other facade treatment elements help break the bulk to this part of the building.

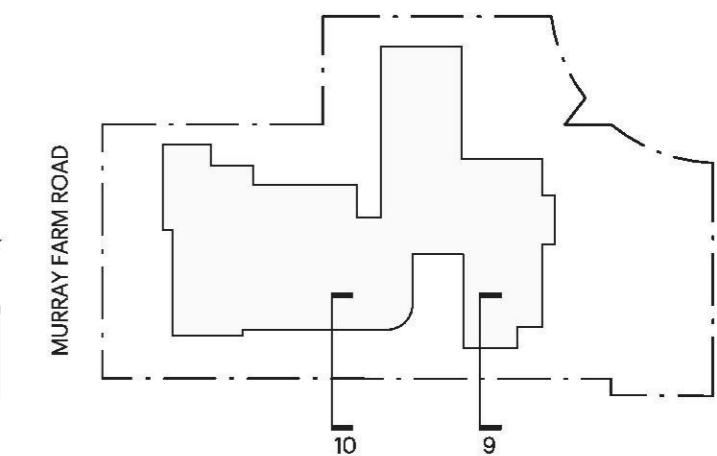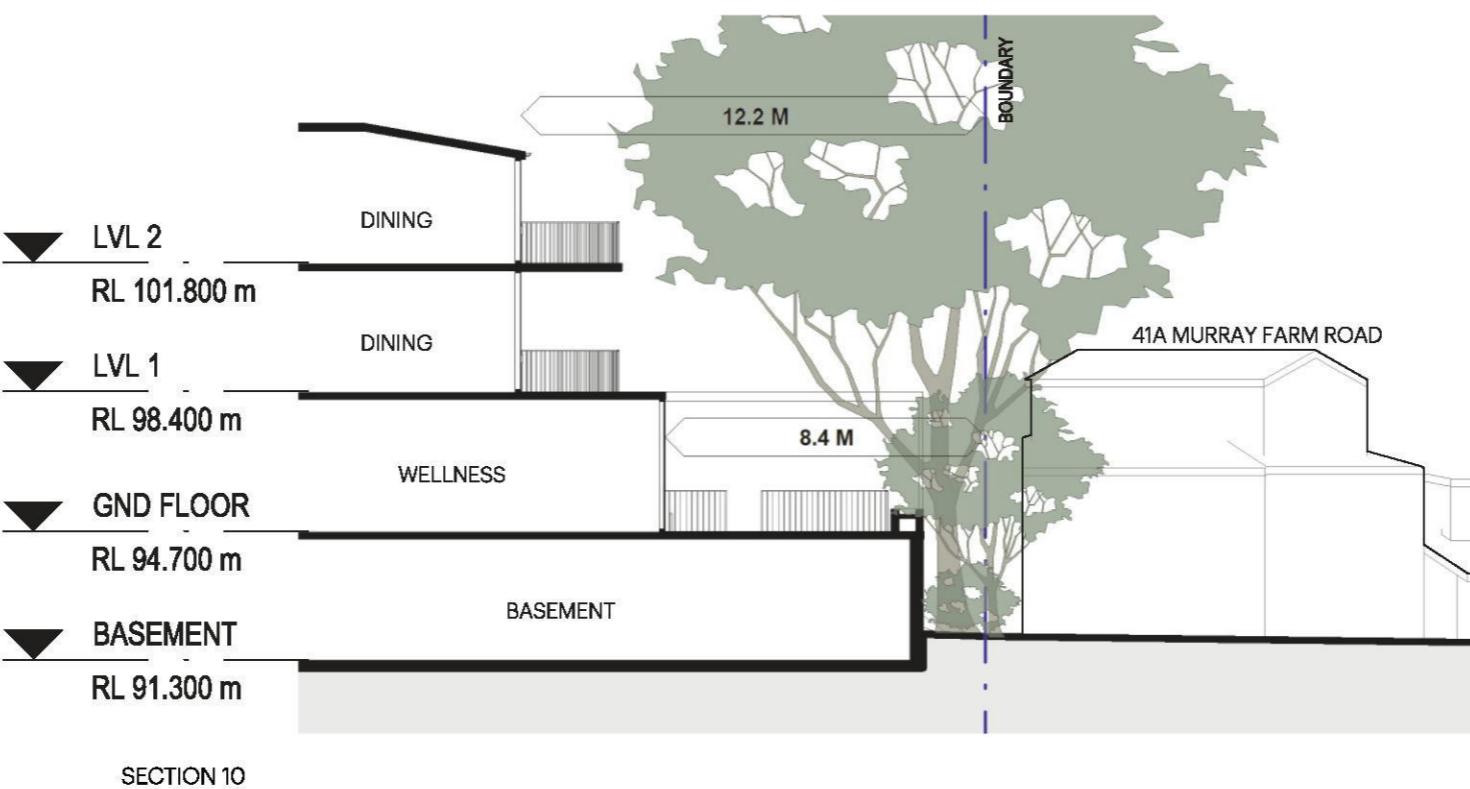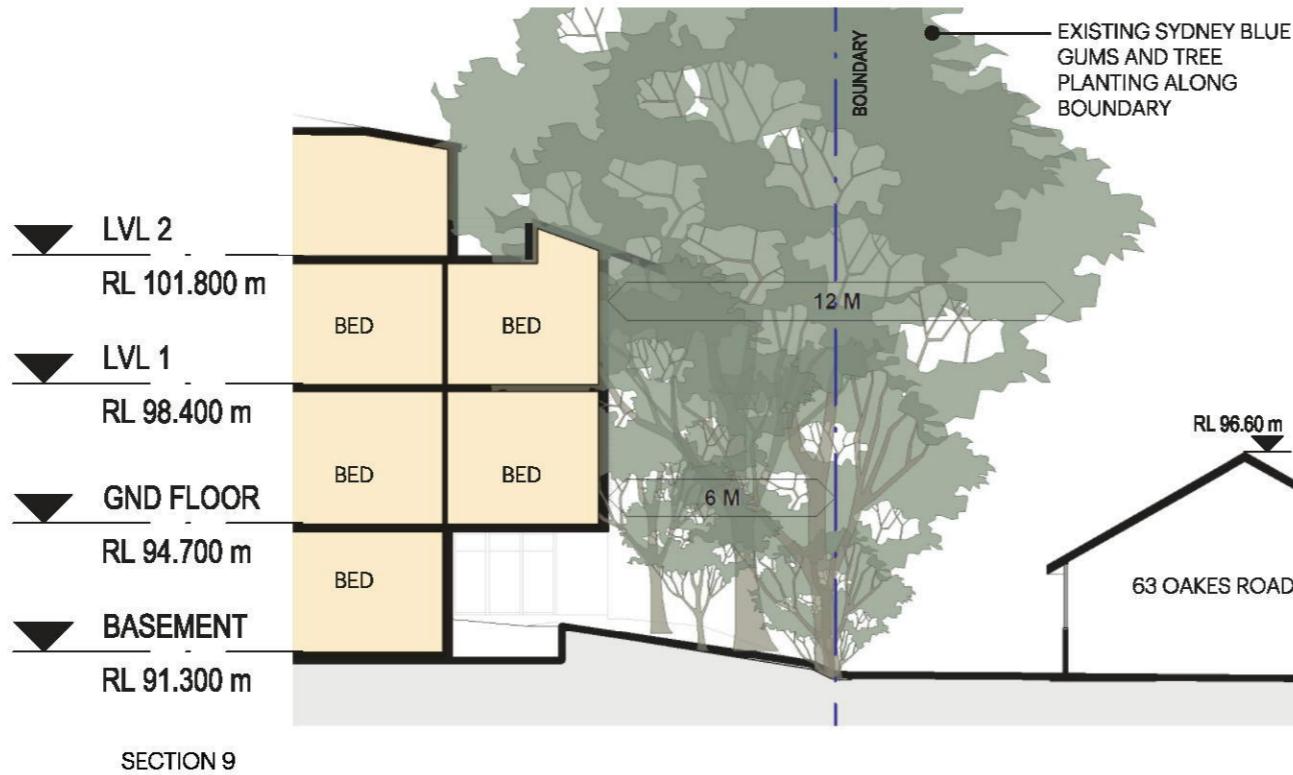

BOUNDARY CONDITIONS

The two-storey built form and timber pergola over the driveway creates a seamless and softened transition to the proposed facility. There's a significant setback of more than 30 meters between the proposed building and the neighbouring property at 39 Oakes Road. The private open space of 39 Oakes Road is protected by the existing dense foliage of trees which are proposed to be retained.

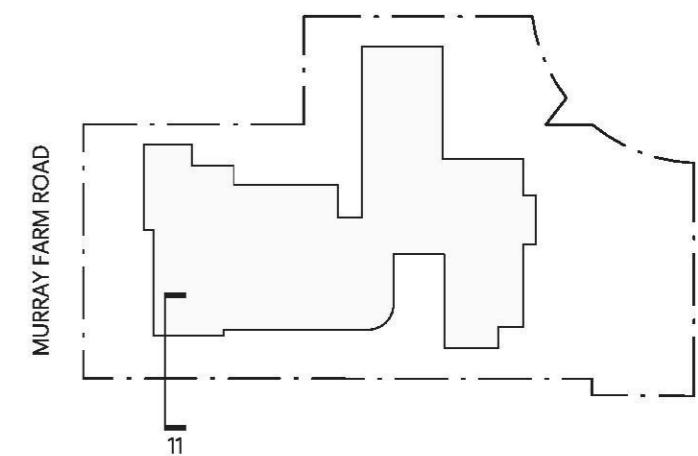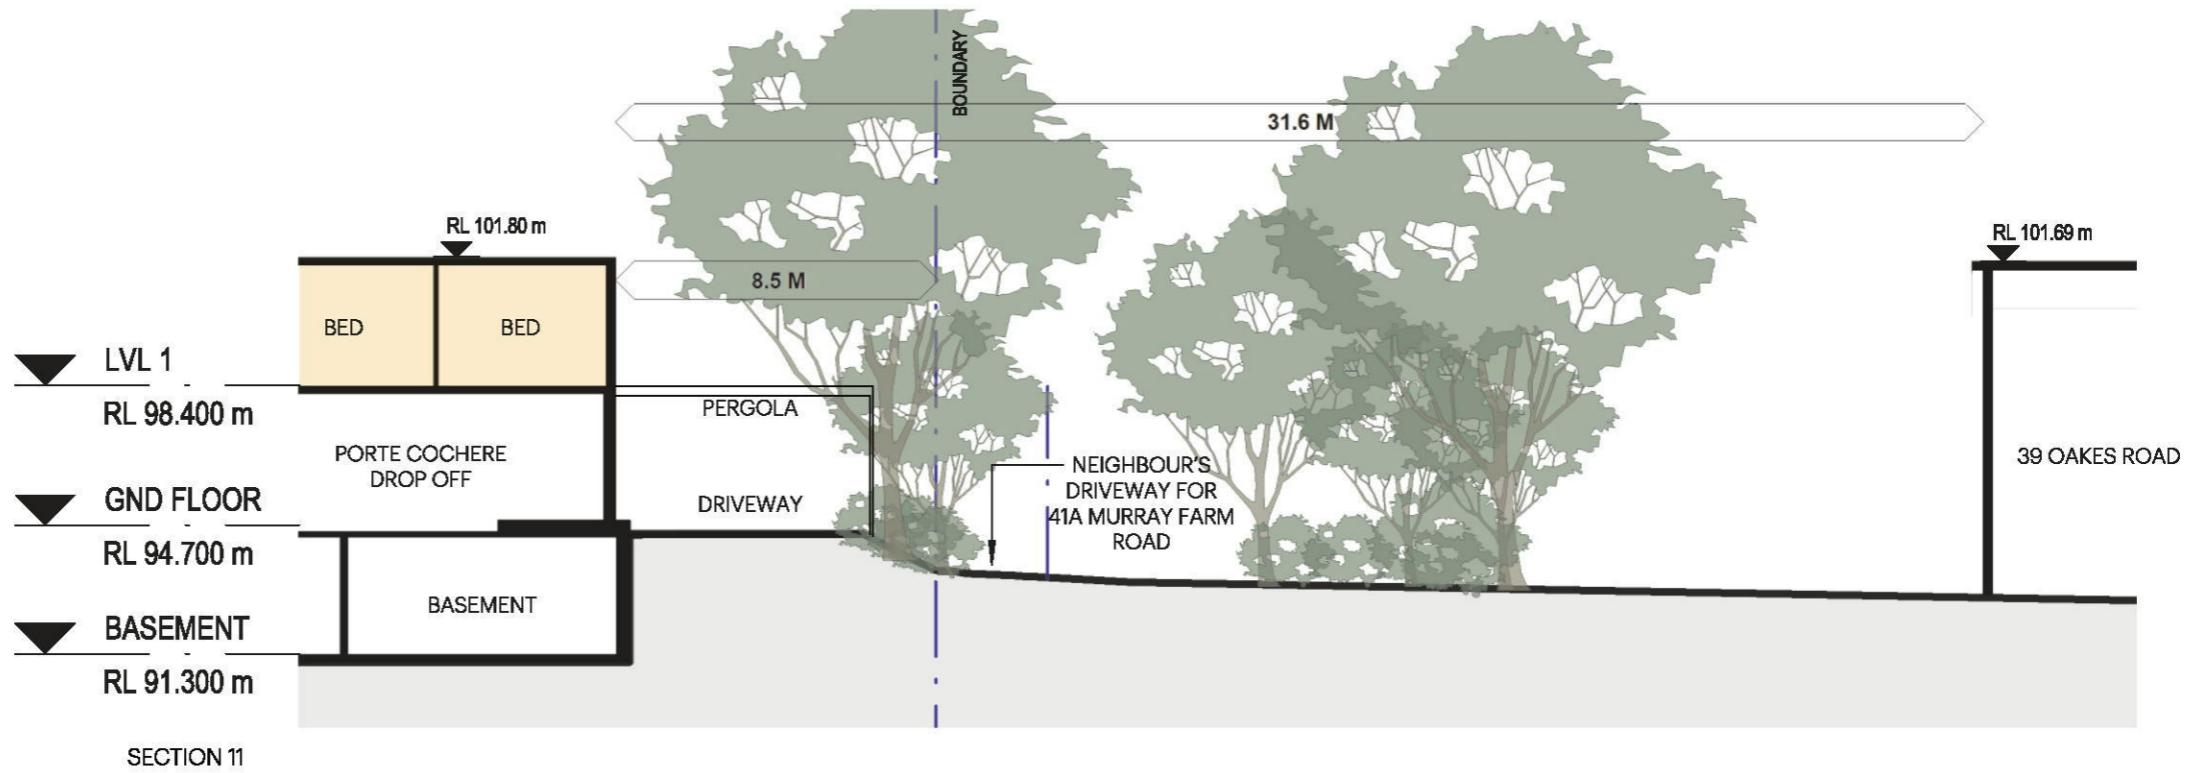

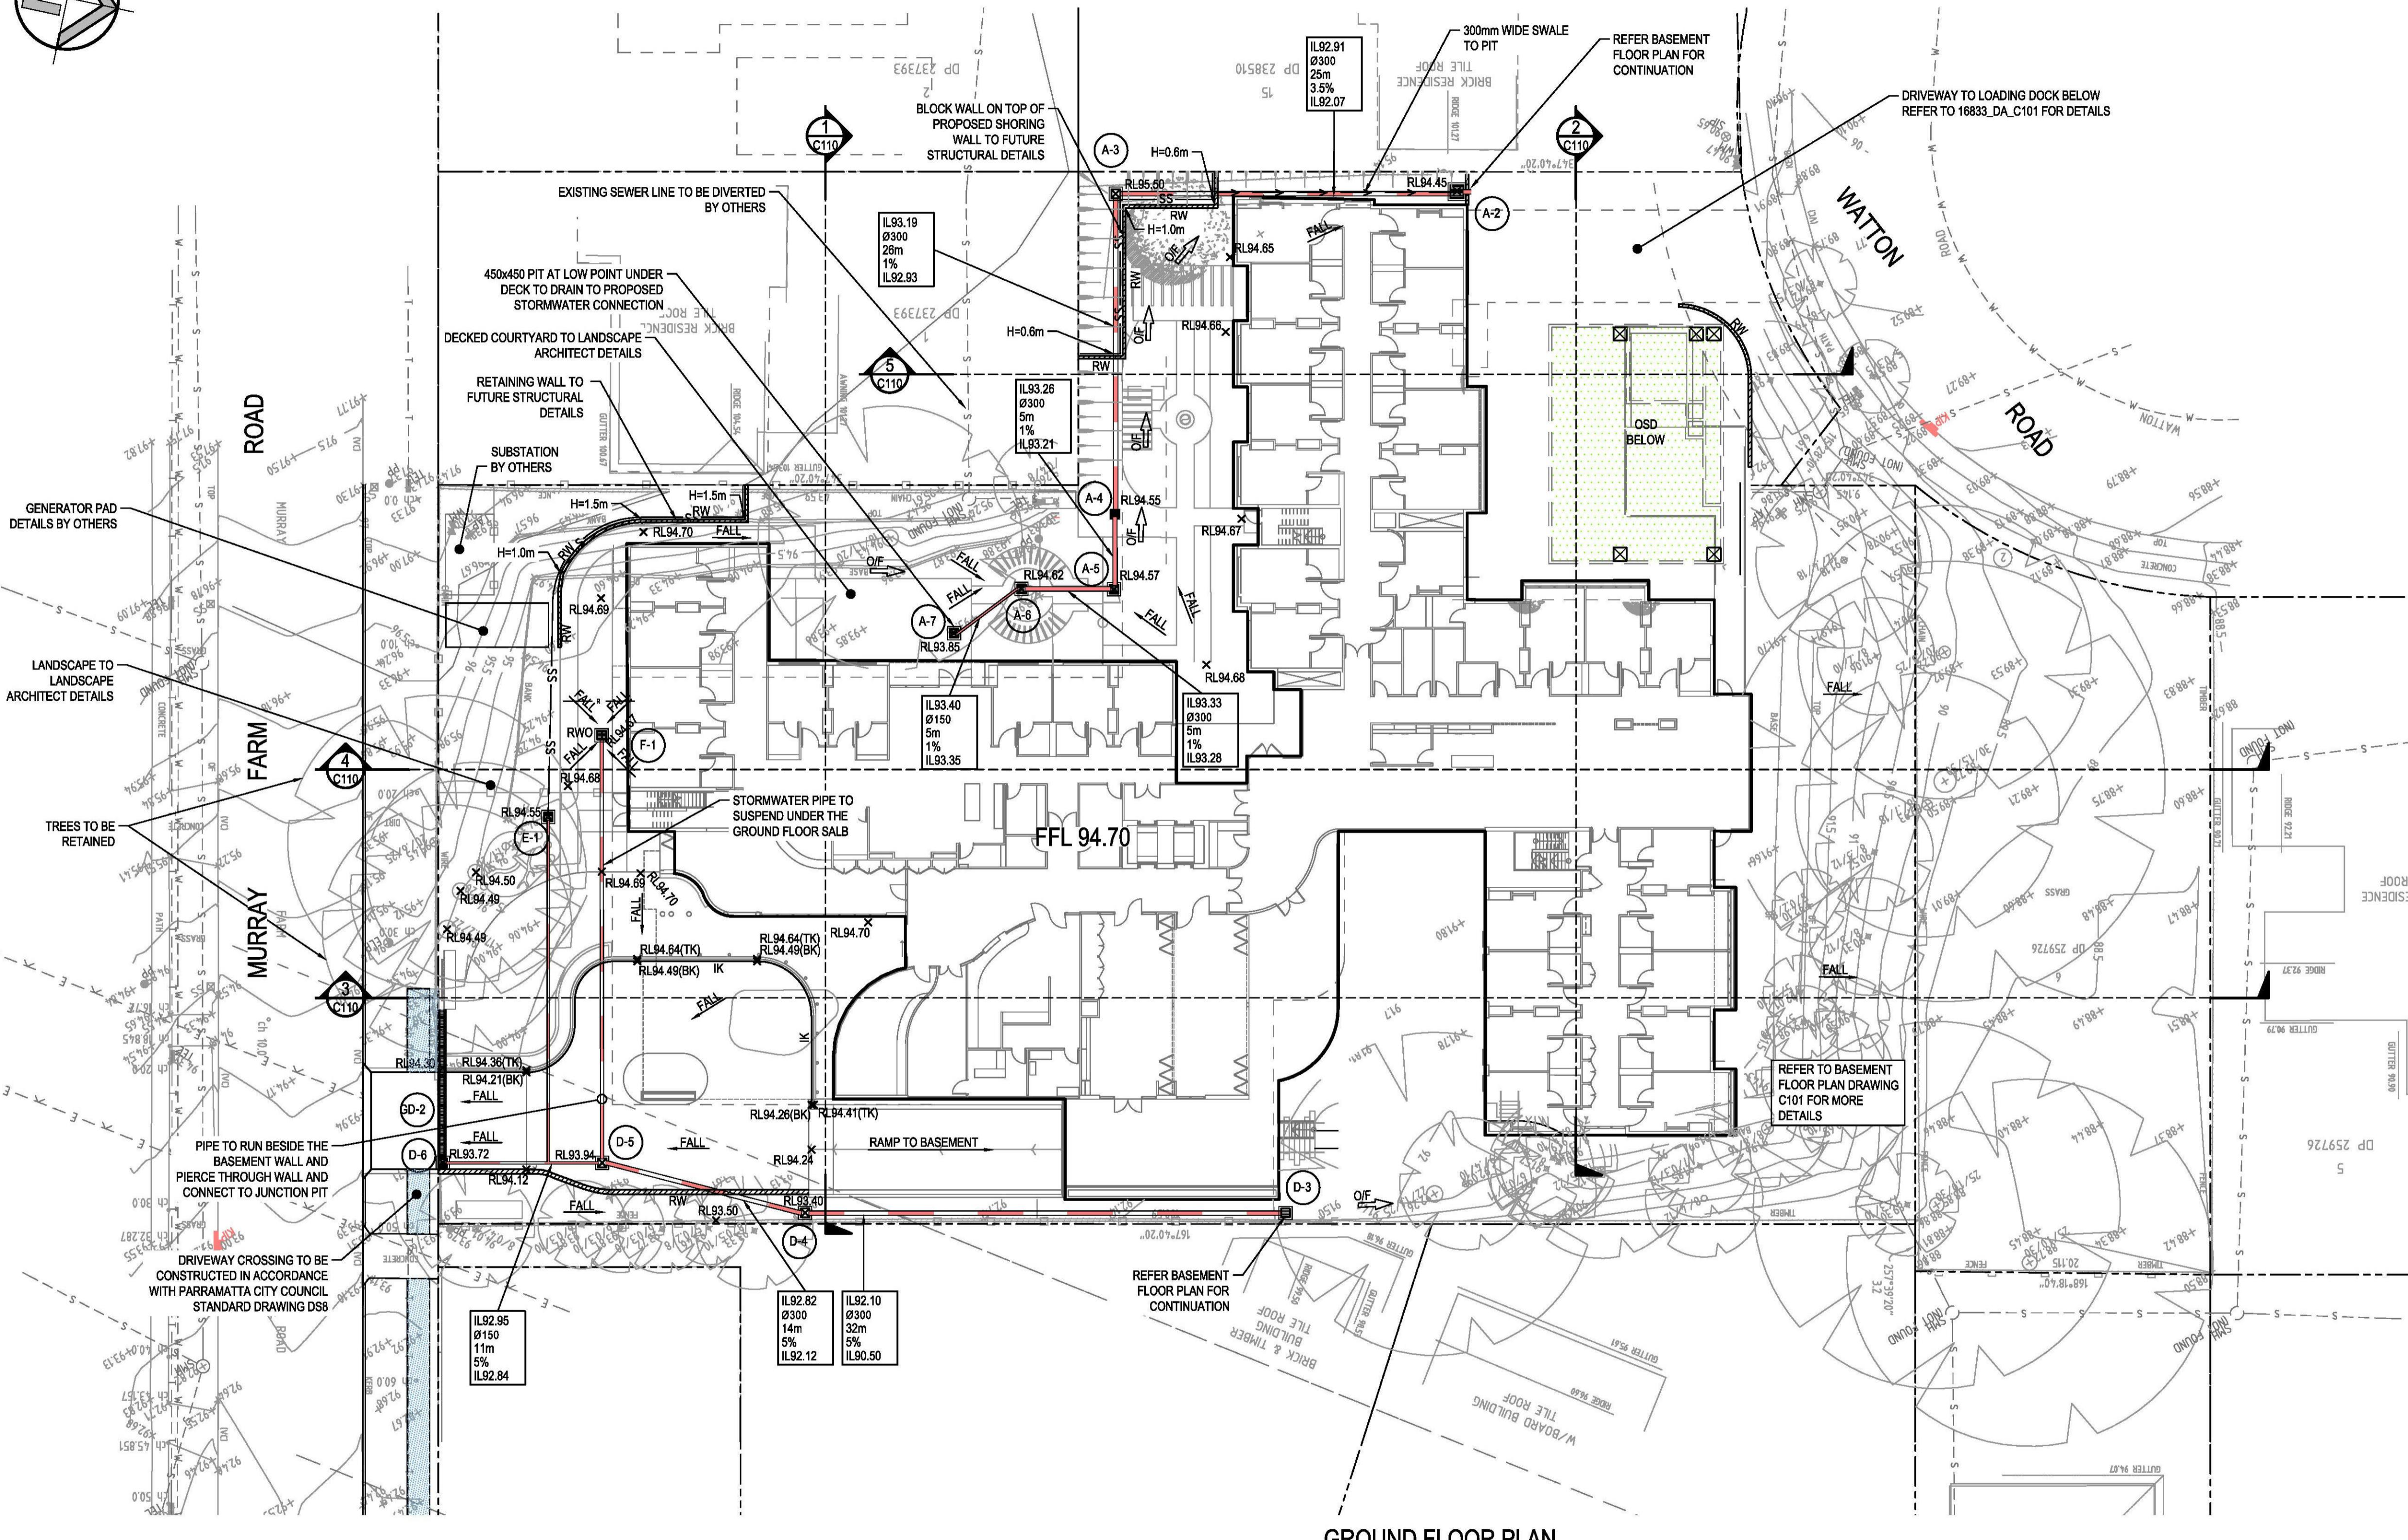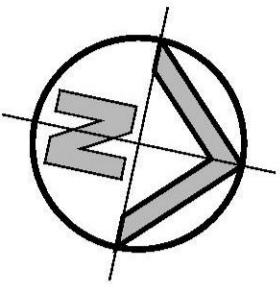

LEGEND	
PROPOSED BOUNDARY	-----
PROPOSED SWALE	→ → → →
PROPOSED JUNCTION PITS	☒ ☒ ☒ ☒
PROPOSED SURFACE INLET PITS	■ ■ ■ ■
PROPOSED GRATED DRAIN	—
PROPOSED STORMWATER PIPE	—
PROPOSED RIANWATER OUTLET	—
PROPOSED RETAINING WALL	—
PROPOSED CONTOURS	—
PROPOSED SPOT LEVEL	X
PROPOSED TOP OF KERB	X
PROPOSED BACK OF KERB	X
EXISTING SPOT LEVEL	•
EXISTING CONTOURS	—
PROPOSED INTEGRAL KERB	—
PROPOSED BATTER LINE	—
STORMWATER UPSTREAM INVERT RL.	A6.125
STORMWATER PIPE DIAMETER & CLASS	Ø425CP
STORMWATER PIPE LENGTH	20.450m
STORMWATER PIPE GRADE	1.5%
STORMWATER DOWNSTREAM INVERT RL.	39.818
PROPOSED FALL	FALL
EXISTING TREE	Tree icon
EXISTING SEWER LINE	—
EXISTING ELECTRICAL MAINS LINE	—
EXISTING TELSTRA LINES	—
EXISTING WATER LINE	—
OVERLAND FLOW PATH	O/F
PROPOSED PIT TAG	A-1

FOR DA ONLY

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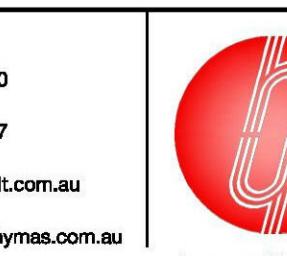
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03 ISSUED FOR DA ONLY	KSR IA 07.12.2018
02 ISSUED FOR INFORMATION ONLY	KSR IA 05.12.2018
01 ISSUED FOR INFORMATION ONLY	JK IA 30.11.2018
REVISION	AMENDMENT DRAWN DESIGNED DATE REVISION


Client: HB + B PROPERTY
Architect: THOMSON ADSETT
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Project: PROPOSED AGED CARE DEVELOPMENT
47 MURRAY FARM ROAD, CARLINGFORD NSW
Title: GROUND FLOOR PLAN
Drew J.Knight Designed I.Ahmed Date NOV 2018
Checked A.Francis Approved A.Francis Scale 1:250 @ A1
Drawing number 16833_DA_C100 Revision 06





SURVEY INFORMATION	
SURVEYED BY	
LTS LOCKLEY	
DATUM A.H.D.	
ORIGIN OF LEVELS: SSM1070 RL108.675	
REVISION	AMENDMENT DRAWN DESIGNED DATE REVISION



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Architect
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Project
PROPOSED AGED CARE DEVELOPMENT
47 MURRAY FARM ROAD, CARLINGFORD NSW
Title
BASEMENT FLOOR PLAN
Drawn
J.Knight
Designed
I.Ahmed
Date
NOV 2018
Checked
A.Francis
Approved
A.Francis
Scale
1:250 @ A1
Drawing number
16833_DA_C101
Revision
05

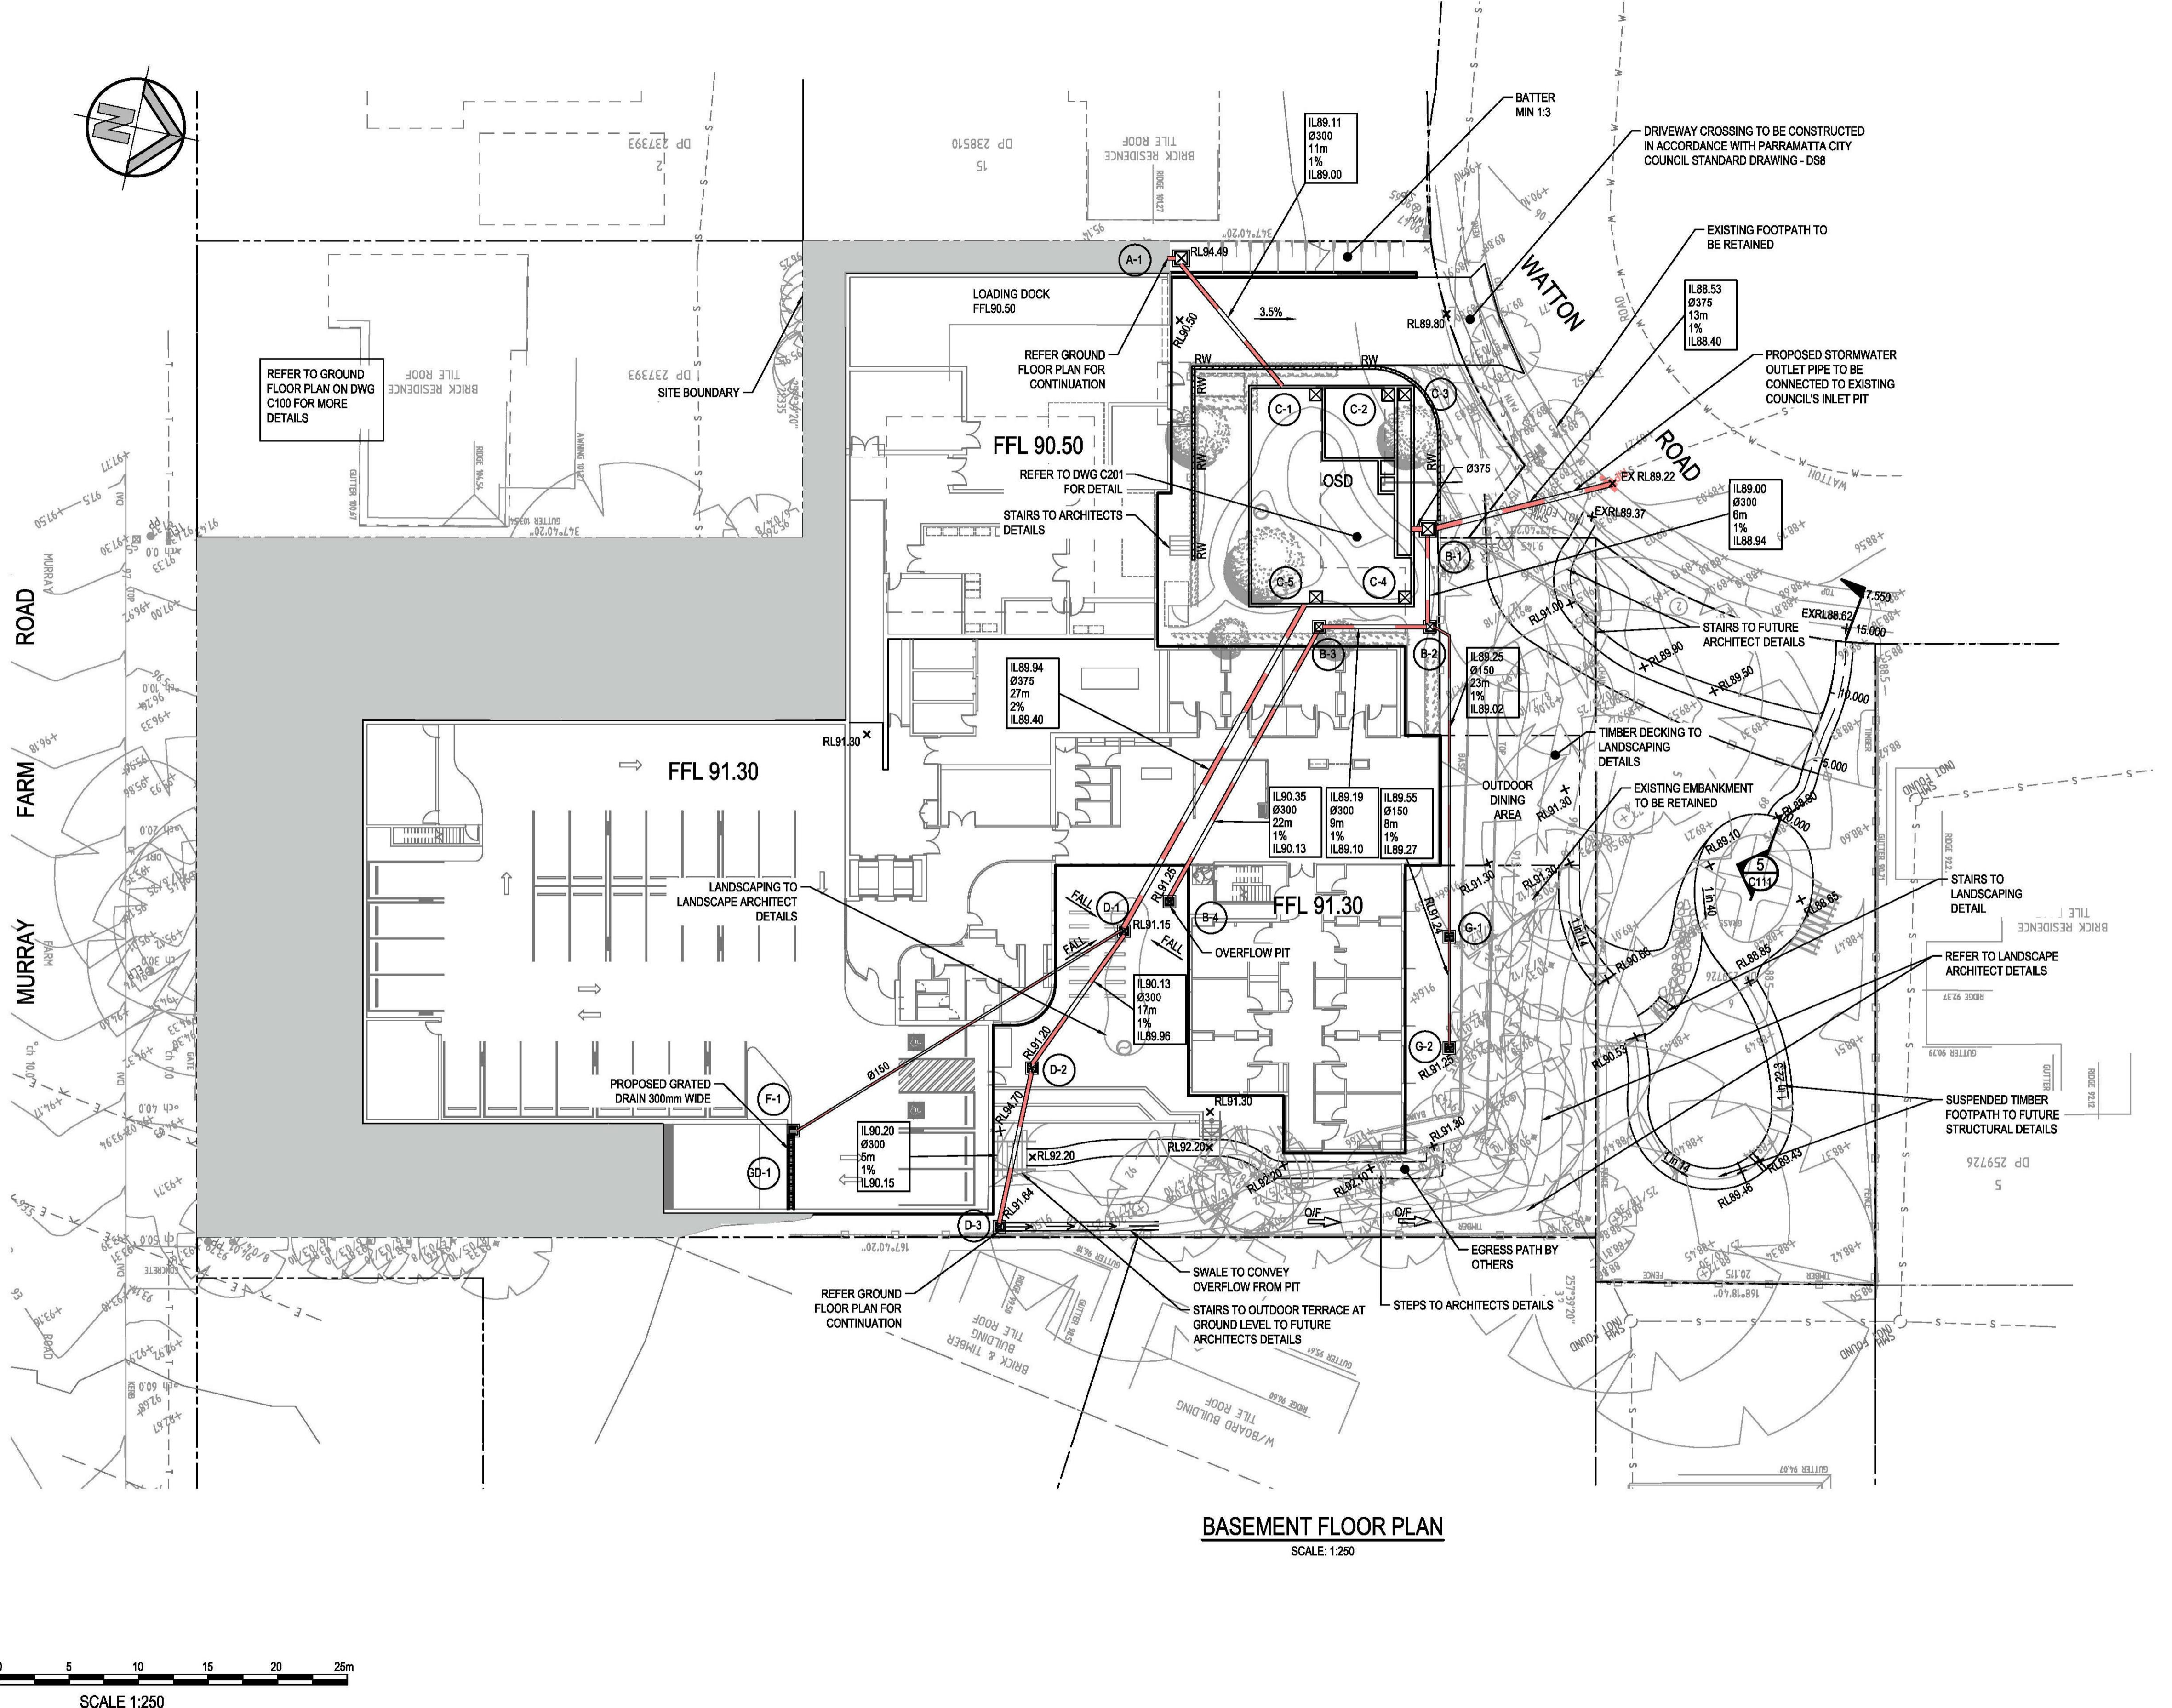FOR DA ONLY



0 5 10 15 20 25m
SCALE 1:250

SURVEY INFORMATION	
SURVEYED BY LTS LOCKLEY DATUM: A.H.D.	
02	ISSUED FOR DA ONLY MC IA 22.08.2019
01	ISSUED FOR DA ONLY KSR IA 07.12.2018

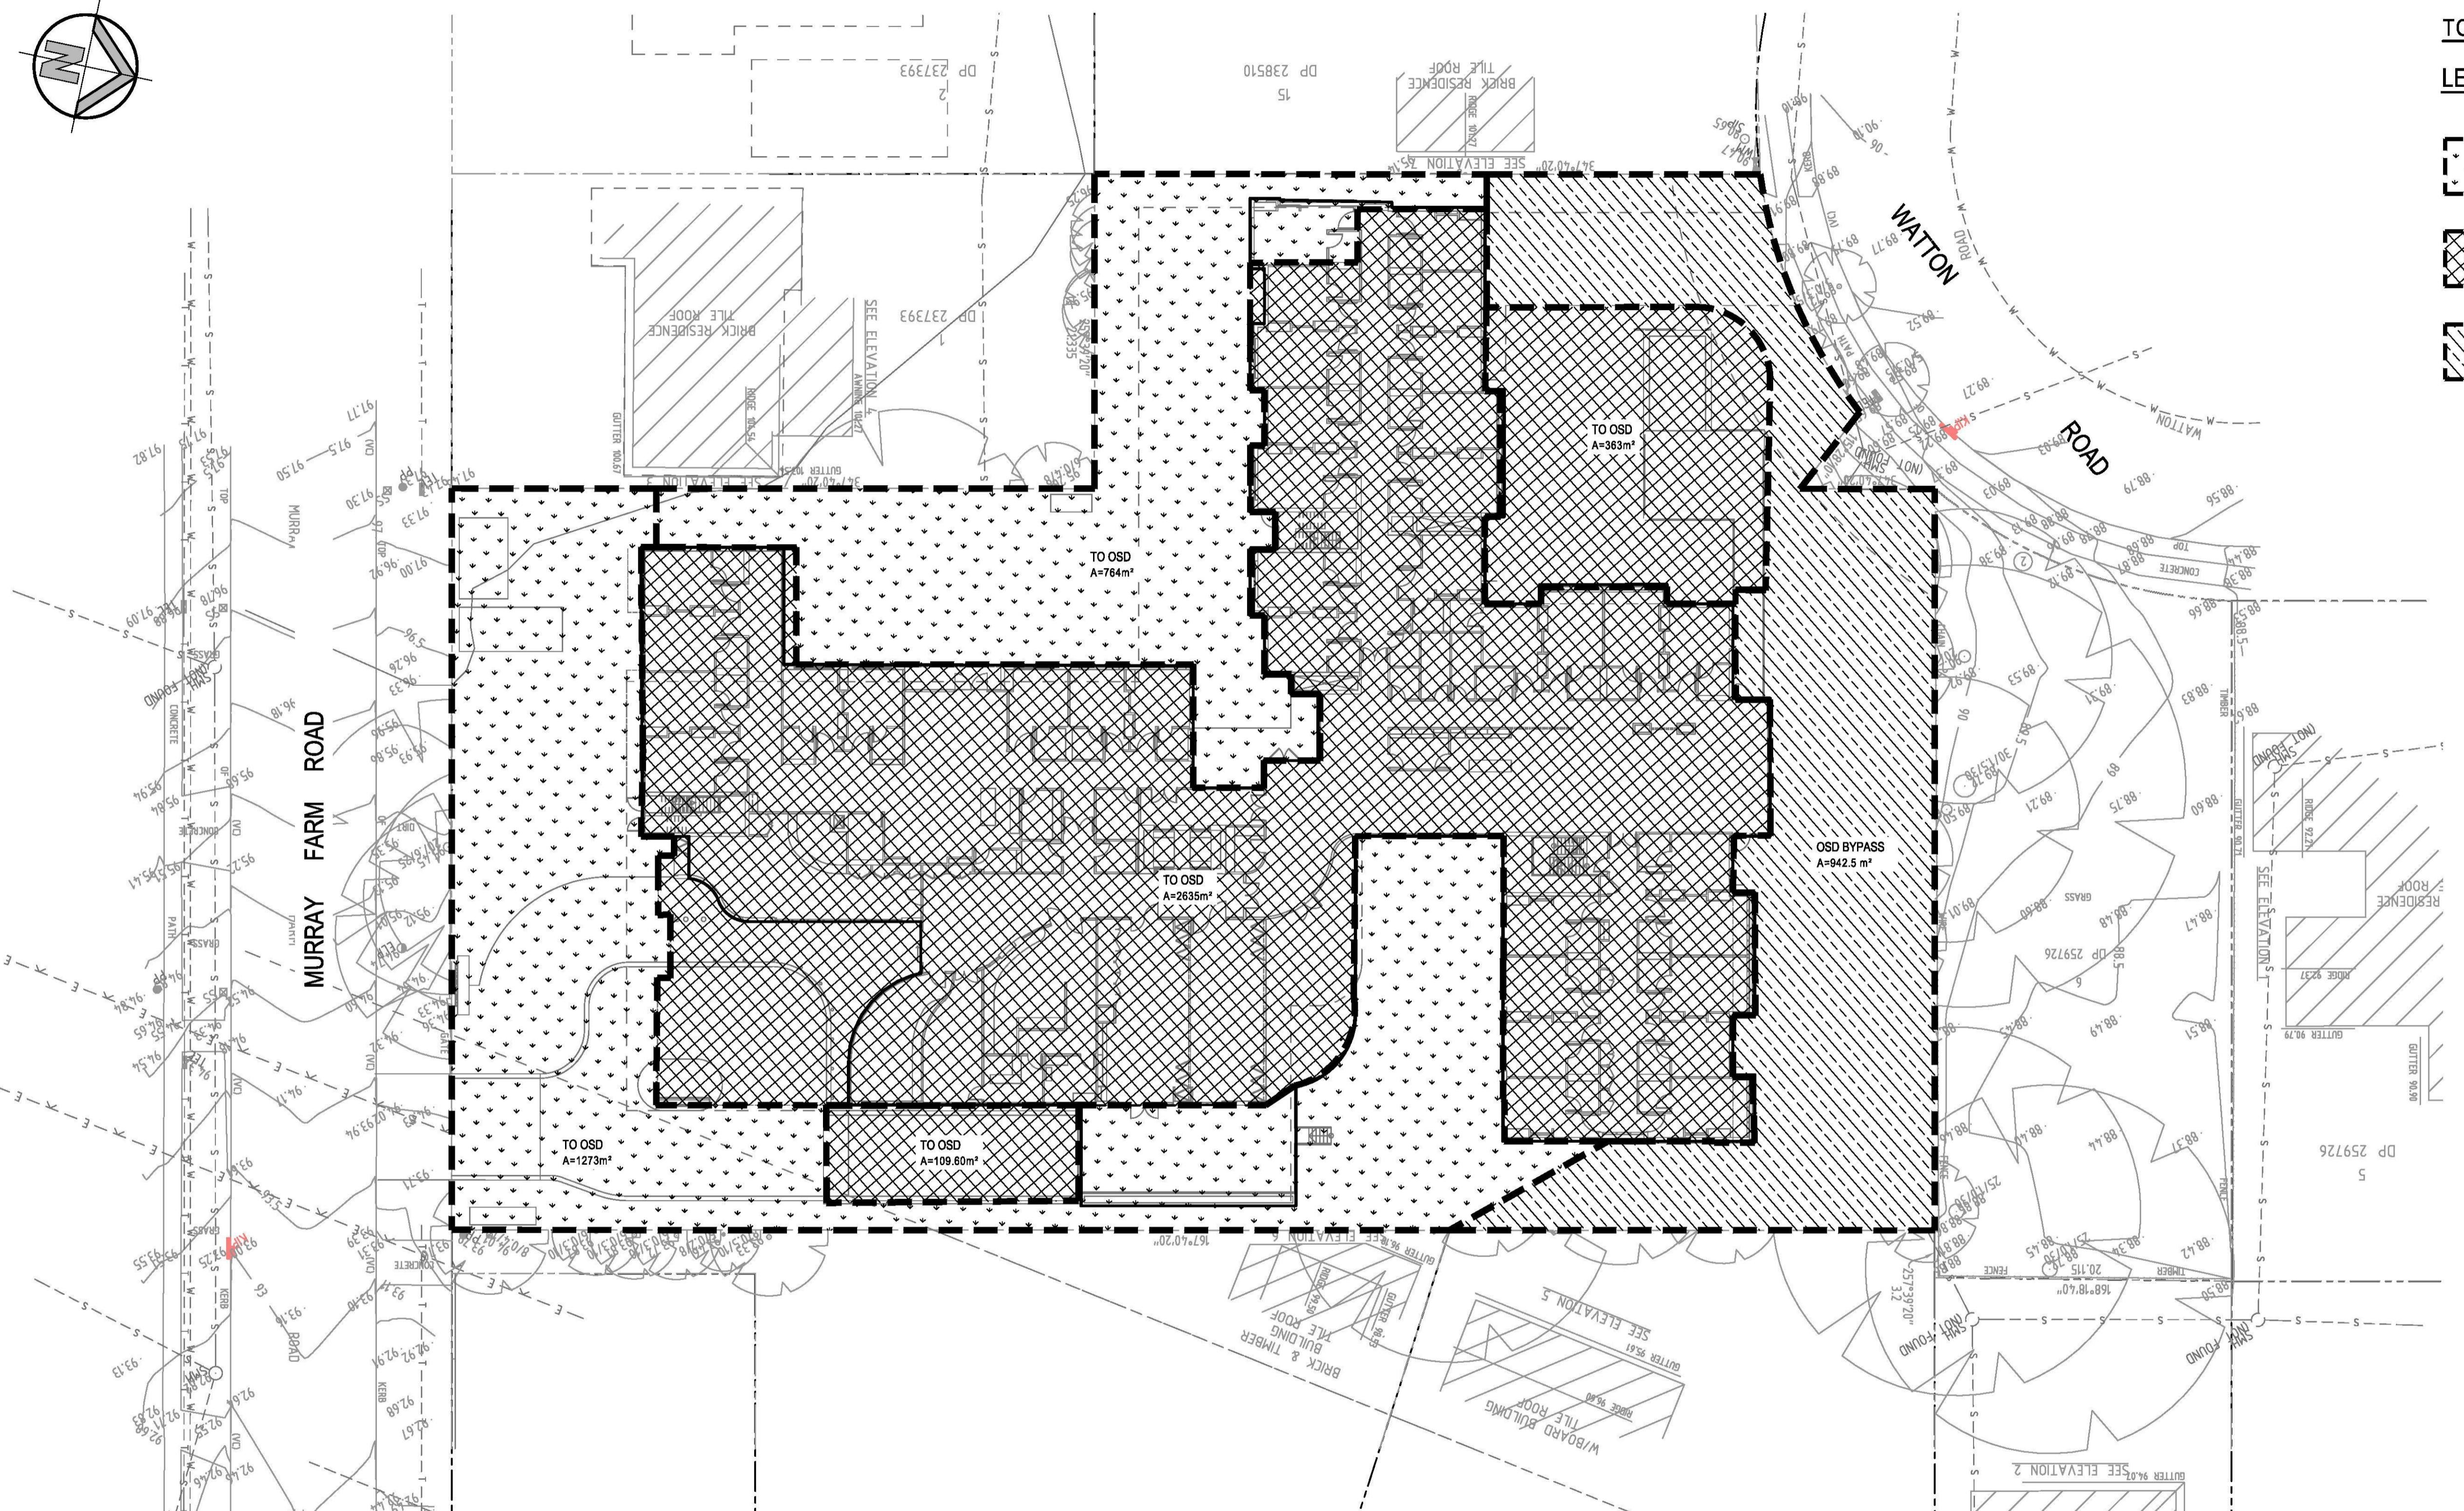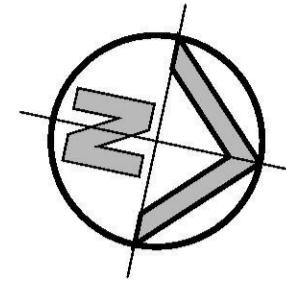REVISION AMENDMENT DRAWN DESIGNED DATE REVISION AMENDMENT DRAWN DESIGNED DATE

ORIGIN OF LEVELS: SSM107070 RL108.675

AMENDMENT

DRAWN

DESIGNED


DATE

REVISION

AMENDMENT

DRAWN

DESIGNED

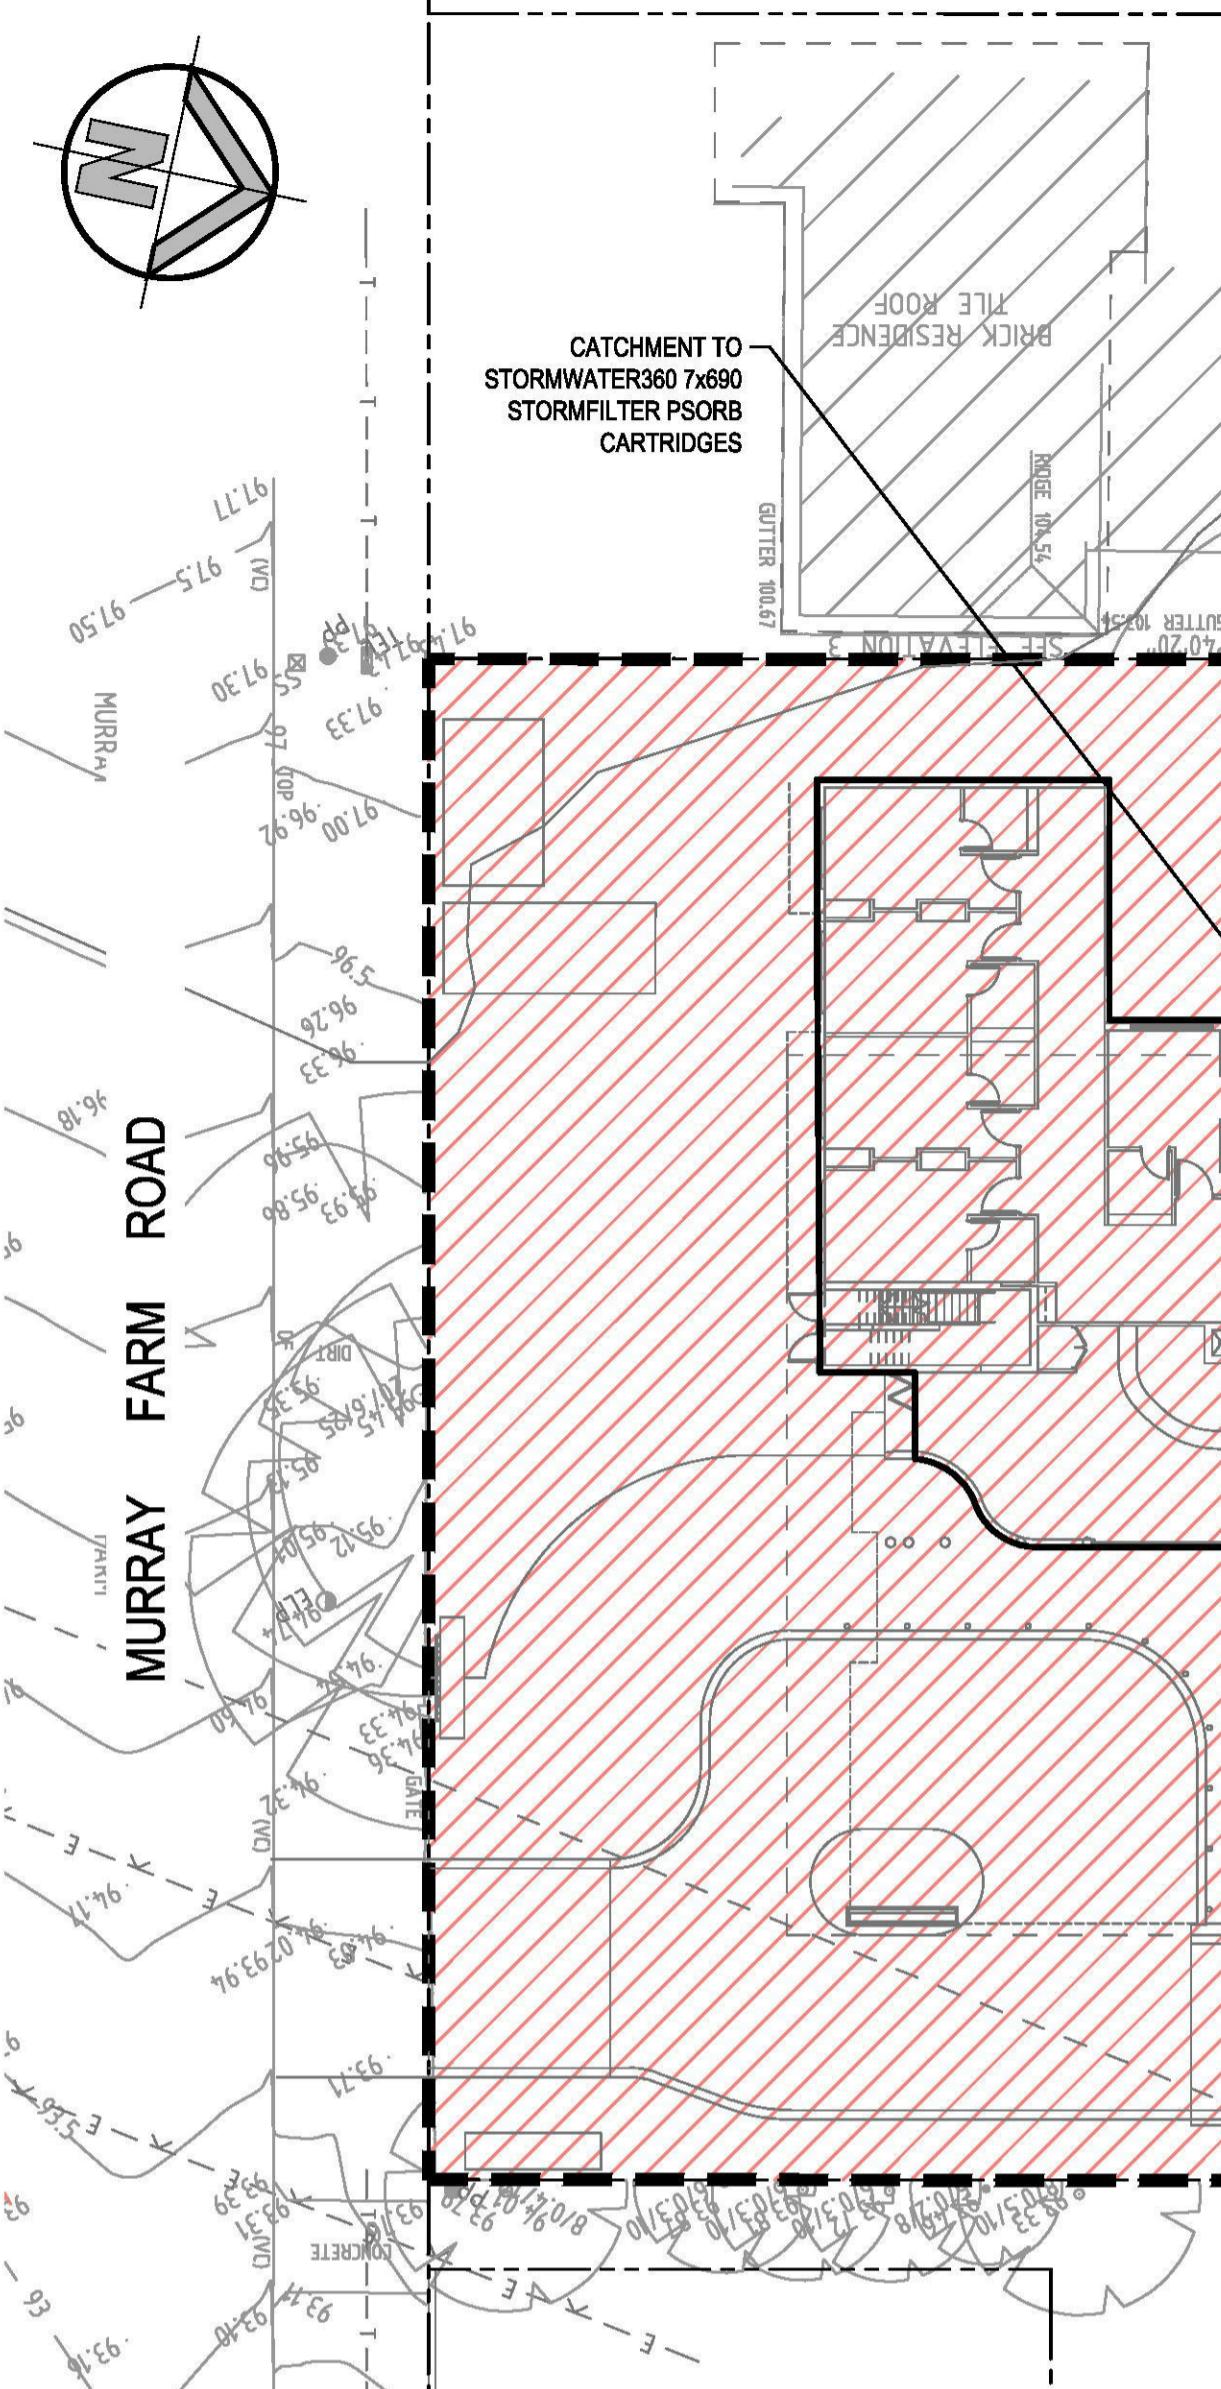


MUSIC MODEL CATCHMENT PLAN

SCALE: 1:250

5 4 3 2 1 0 5 10 15 20 25m
SCALE 1:250

TOTAL SITE AREA = 6,087.5 m²

SITE SPECIFIC DATA REQUIREMENTS	
STRUCTURE ID	OSD STORMFILTER
WATER QUALITY FLOW RATE (L/s)	6.3
PEAK FLOW RATE (L/s)	8.81
RETURN PERIOD OF PEAK FLOW (YRS)	3 MONTHS (21.4mm/hr)
# OF CARTRIDGES REQUIRED	7
CARTRIDGE HEIGHT (310mm/460mm/690mm)	690
MEDIA TYPE (PERLITE, PERLITE/ZEOLITE OR ZPG)	PSORB

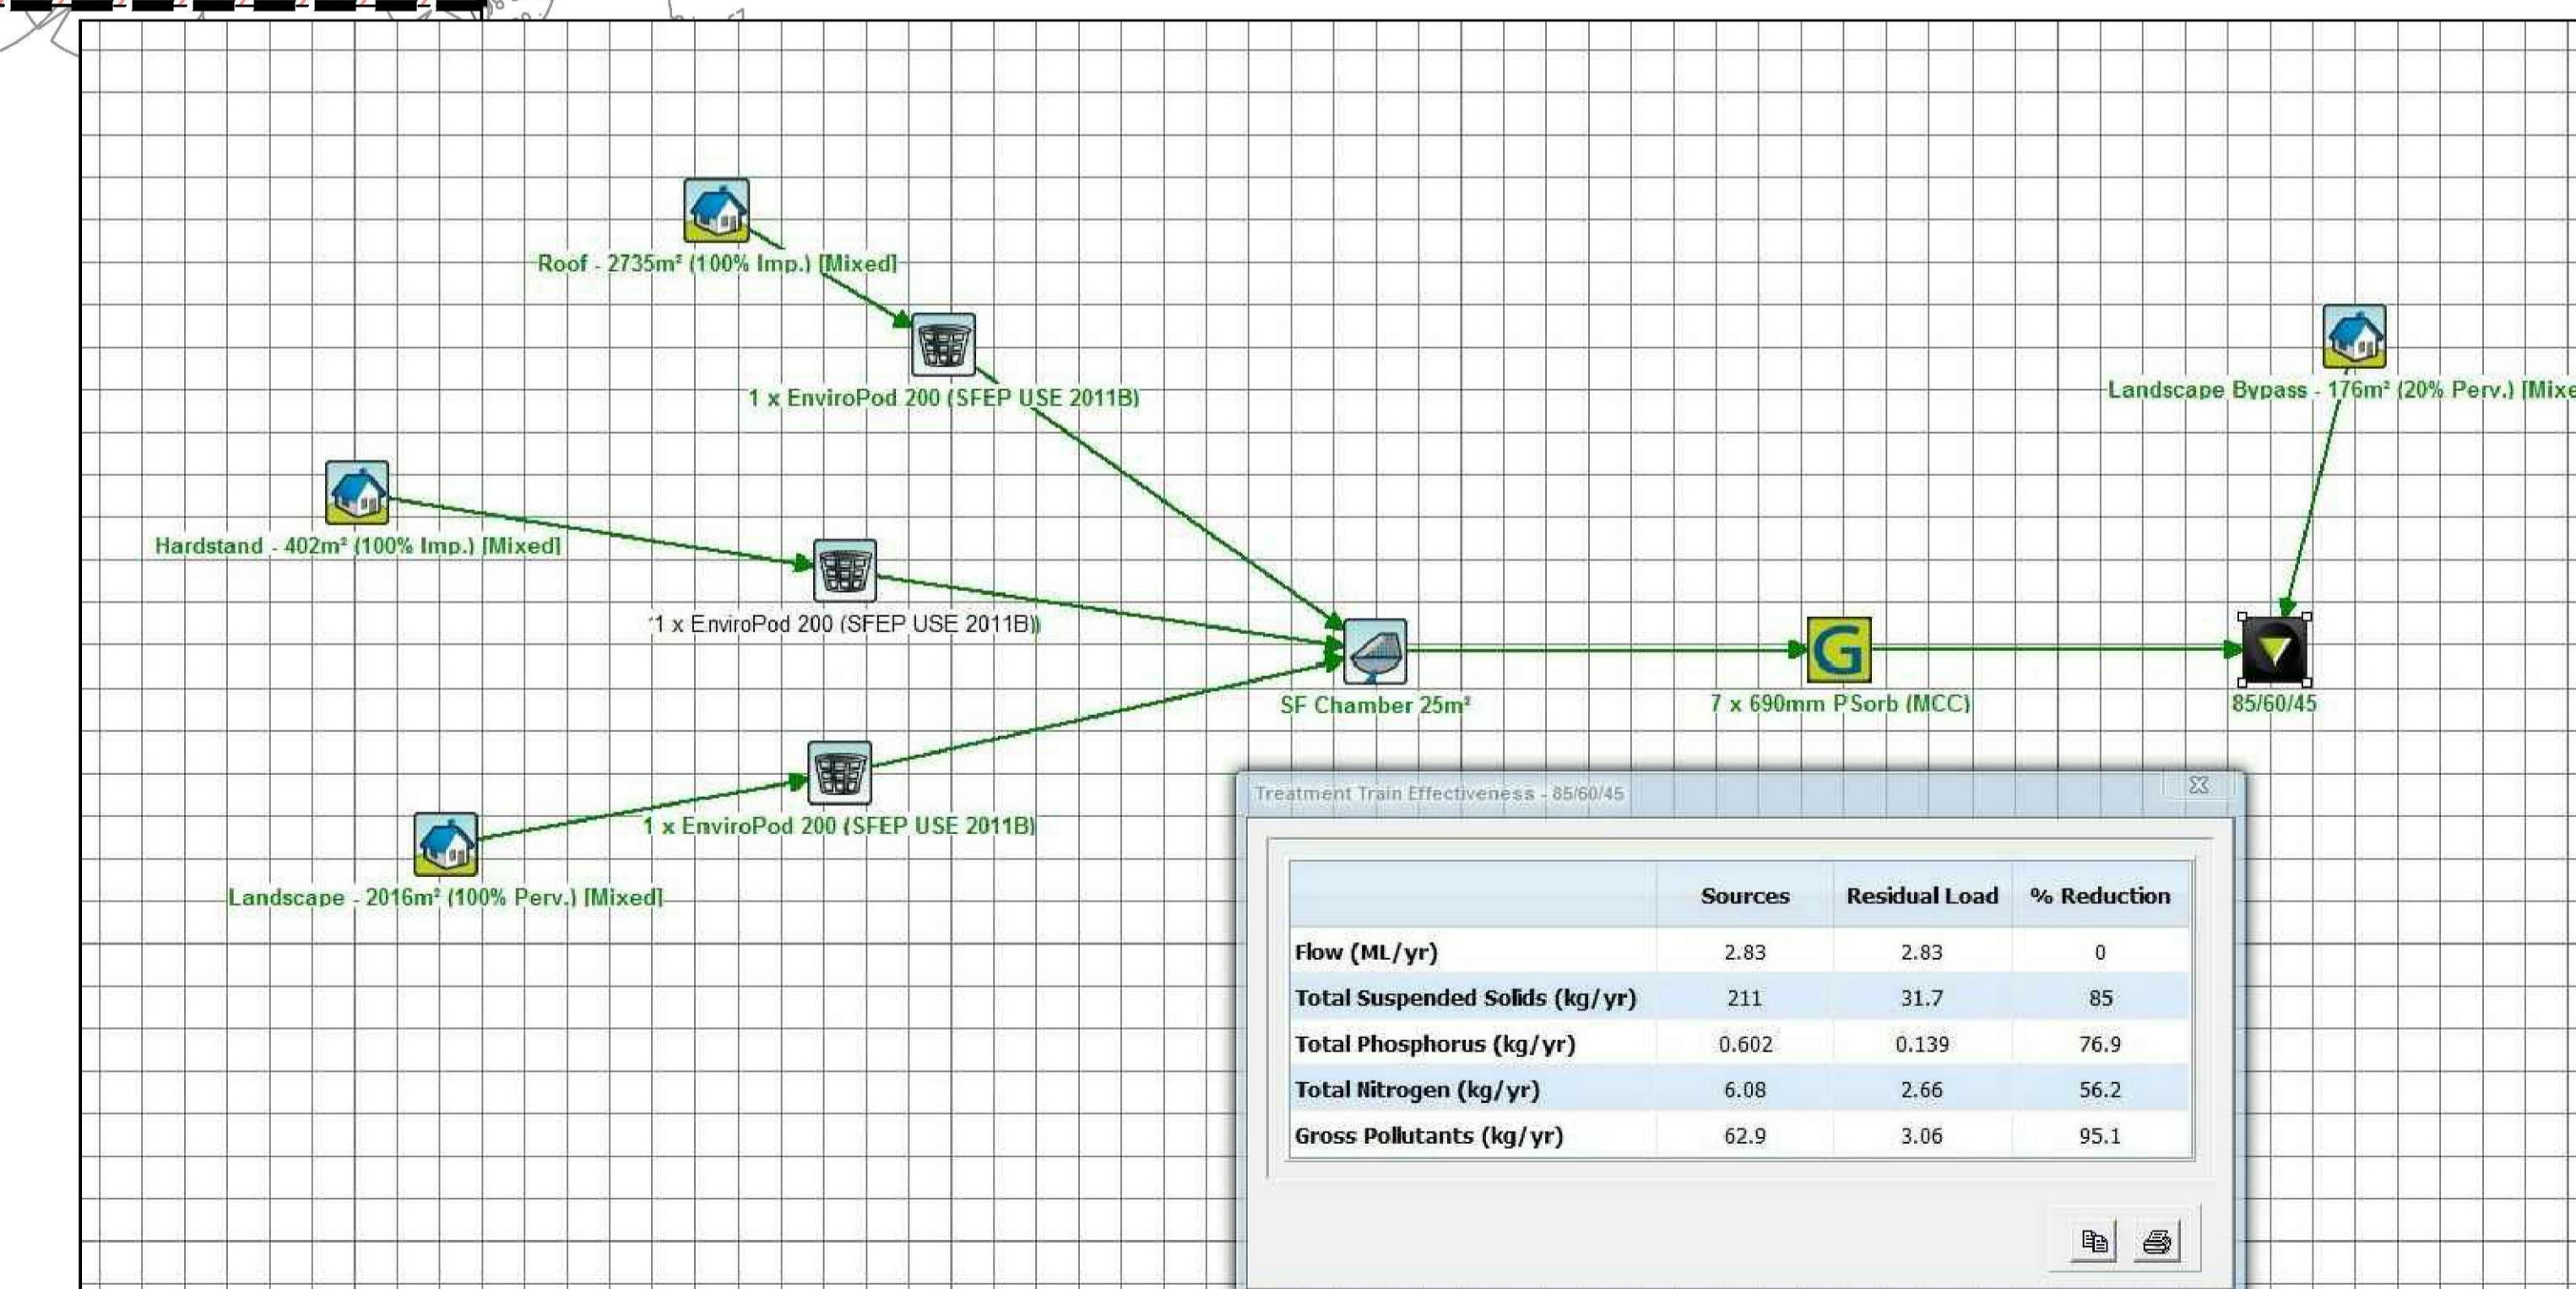

MUSIC MODEL RESULTS

FOR DA ONLY


SURVEY INFORMATION	
ISSUED FOR DA ONLY	MC IA 22.08.2019
ISSUED FOR DA ONLY	KSR IA 07.12.2018
AMENDMENT	DRAWN DESIGNED DATE
REVISION	AMENDMENT DRAWN DESIGNED DATE

Client HB + B PROPERTY	Architect THOMSON ADSETT	Project PROPOSED AGED CARE DEVELOPMENT 47 MURRAY FARM ROAD, CARLINGFORD NSW
Level 5, 79 Victoria Avenue Chatswood NSW 2027	Telephone +61 2 9417 8400 Facsimile +61 2 9417 8337 Email email@hconsult.com.au Web www.henryandhymas.com.au	Drawn J.Knight Designed I.Ahmed Date NOV 2018
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MUSIC MODEL CATCHMENT PLAN

Drawn number
16833_DA_C251
Approved
A.Francis
Drawing number
16833_DA_C251
Scale
02
Revision
02



SCALE 1:200 @ A1
0 2 4 8 12m

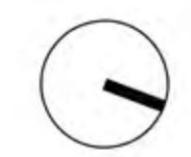LEGEND

- SITE BOUNDARY
- EXISTING TREE RETAINED
- PROPOSED SHRUBS
- PROPOSED TREE
- EXISTING CONTOUR
- PROPOSED NEW CONTOUR
- TOP OF WALL LEVEL
- PROPOSED GROUNDCOVERS
- 1800mm HIGH BOUNDARY FENCE
- WATER FEATURE
- EXISTING SPOT LEVEL
- PROPOSED SPOT LEVEL
- +TW 21.0
- +RL 20.0
- TURF
- BUILDING LINE OVER
- TIMBER DECKING
- PROPOSED PAVING

project: 47 Murray Farm Rd, Carlingford
client: Japara Healthcare
date: 12.09.2019
revision: B
drawn: RY
checked: DMT







project: 47 Murray Farm Rd, Carlingford
client: Japara Healthcare
date: 12.12.2018
revision: B
drawn: RY
checked: DMT

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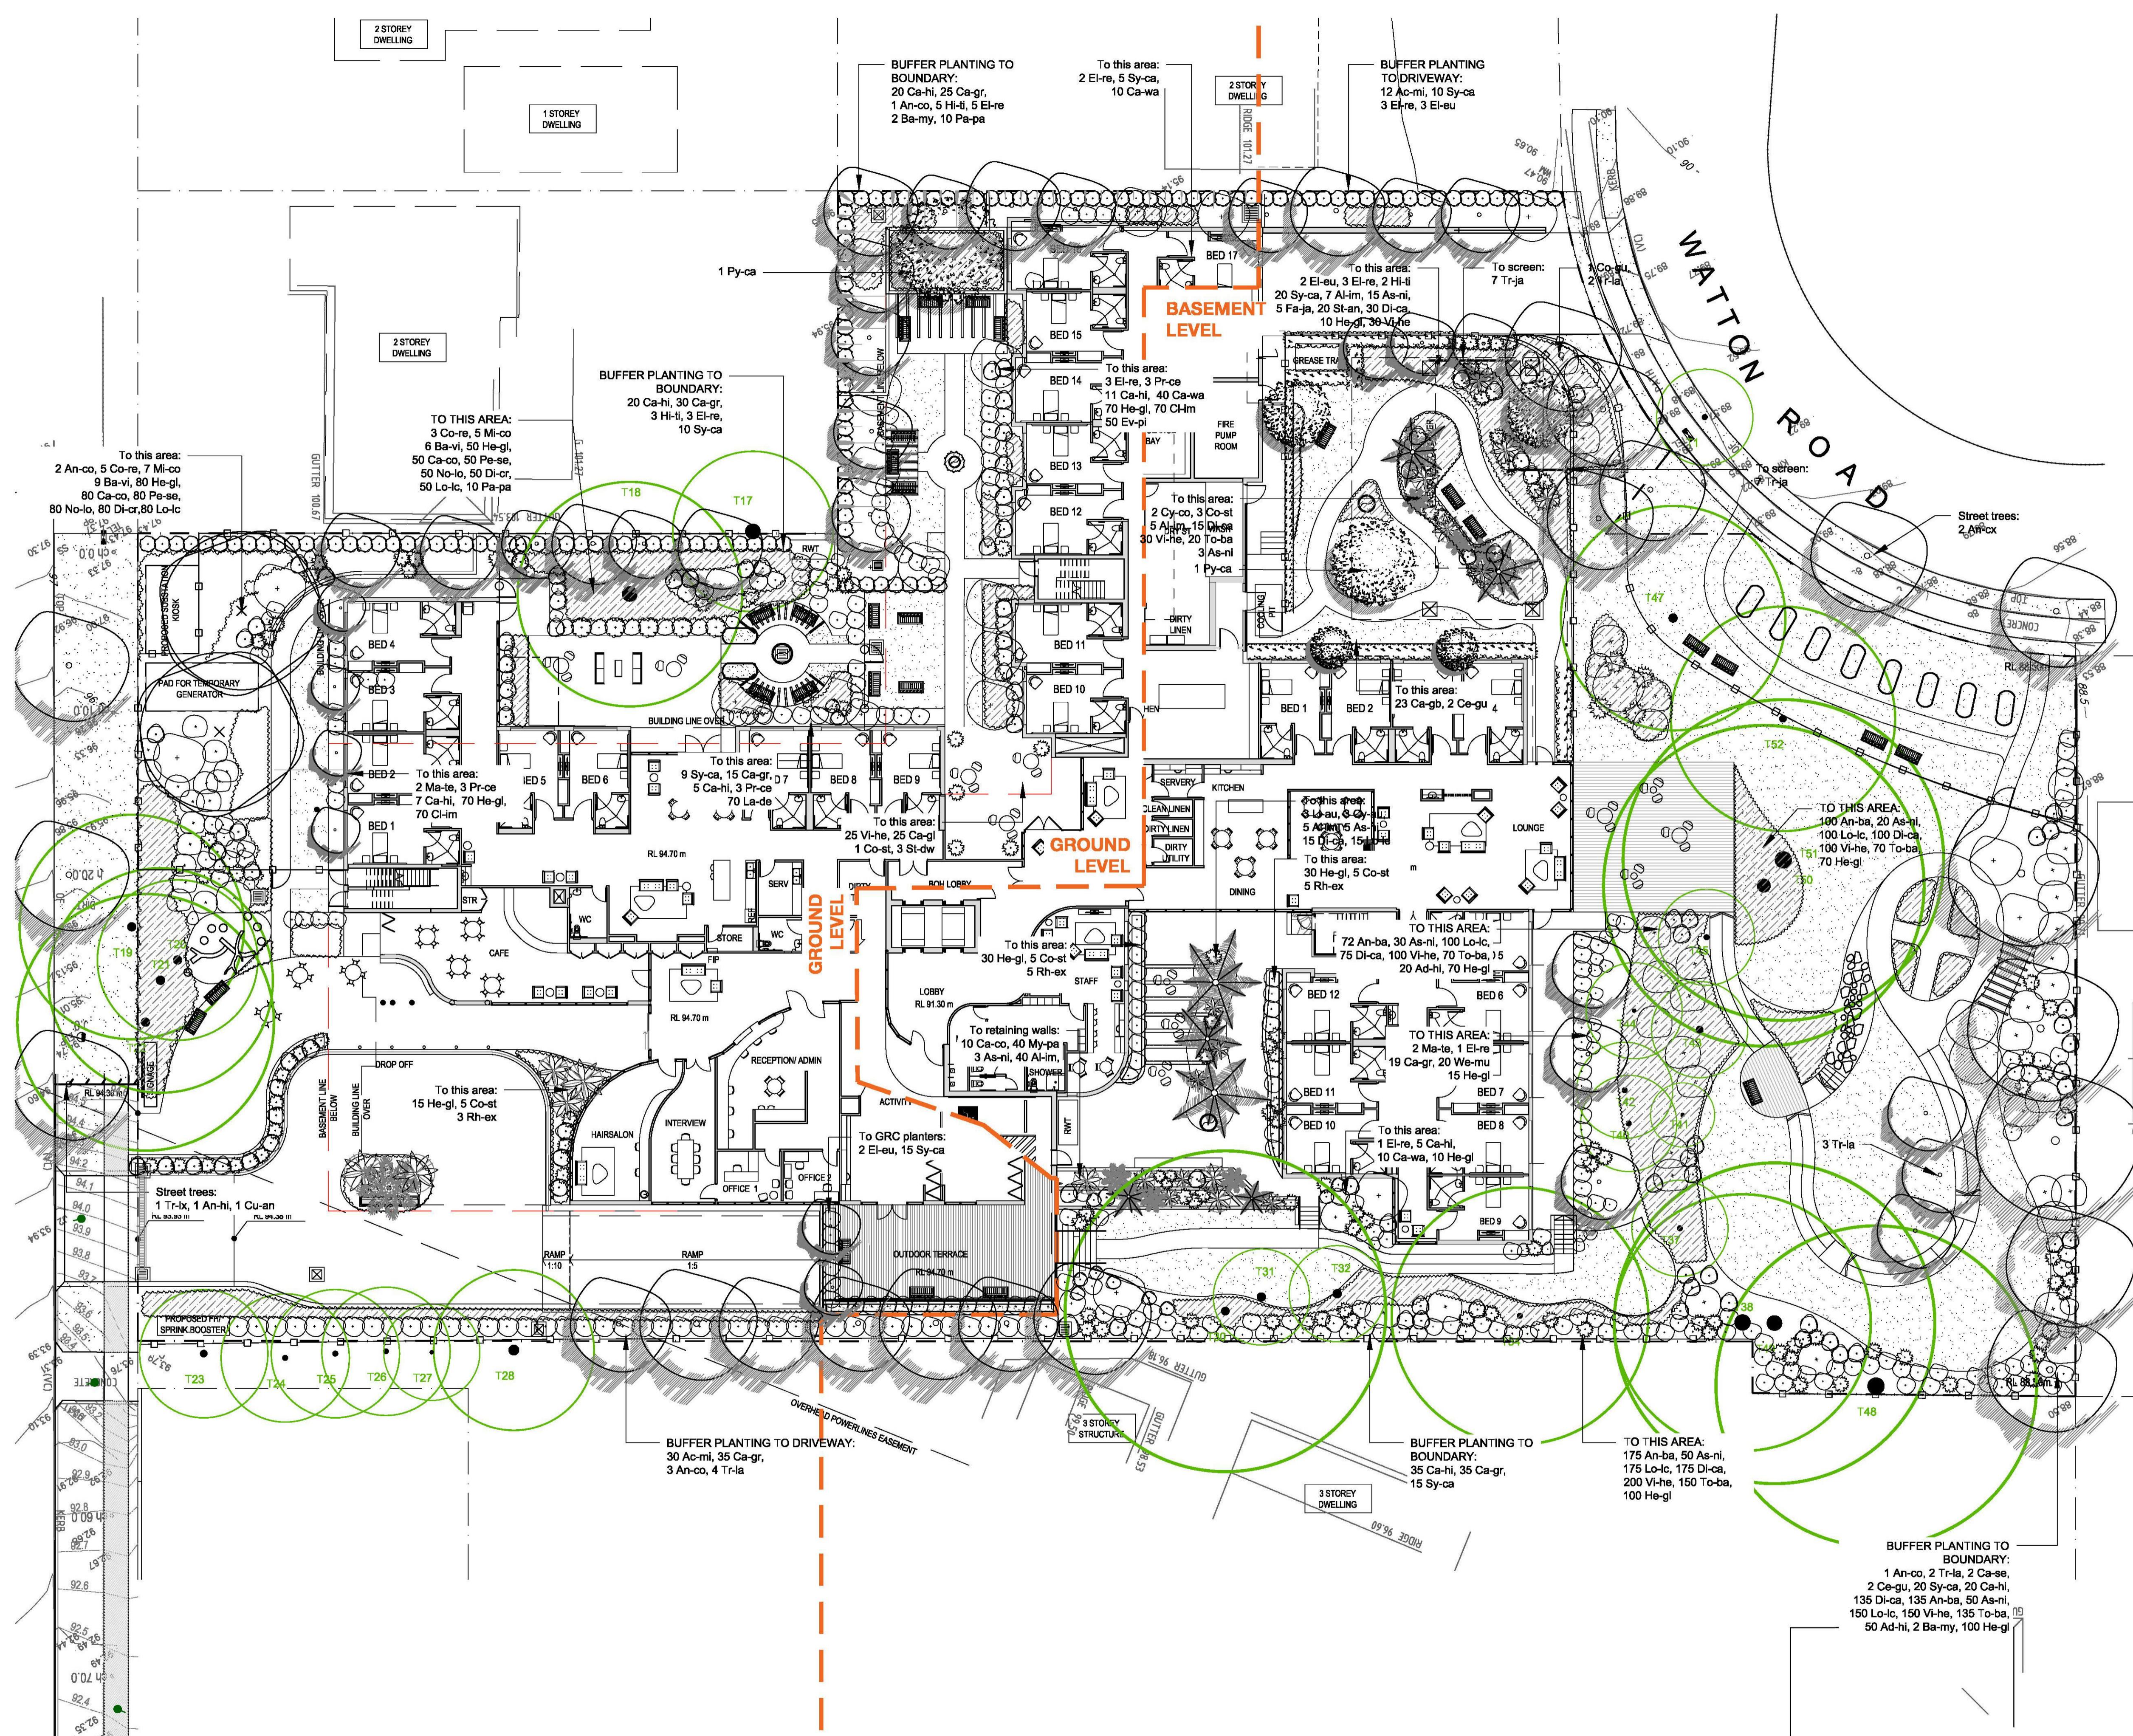
LA05



AUSTRALIAN BUSHLAND GARDEN

- 01 EXISTING TREES RETAINED WITH NEW LOW PLANTING UNDER
- 02 PLANTING BUFFER TO BOUNDARY FENCE TO PROVIDE SCREENING
- 03 COMBINATION OF EVERGREEN AND DECIDUOUS PLANTING TO PROVIDE AMENITY AND SEASONAL INTERESTS
- 04 SANDSTONE BLOCK RETAINING WALL WITH TIERED PLANTING TO SOFTEN WALLS
- 05 GREEN ISLAND WITH FERN AND PALM TO COURTYARD
- 06 LOW HEDGING TO PROVIDE PRIVACY TO RESIDENTS' BEDROOMS
- 07 PERGOLA AND SHADED SITTING AREA
- 08 OUTDOOR DINING AREA TO ELEVATED TIMBER DECK
- 09 ACCESSIBLE ELEVATED TIMBER BOARDWALK OVER TPZ OF EXISTING TREES WITH RESTING BAYS AND SEATING
- 10 INFORMAL PATHWAY
- 11 RESIDENTS VEGETABLE GARDEN
- 12 SECURITY FENCE AND GATE TO COMMUNAL GARDEN REFER TO LA05 FOR COMMUNAL GARDEN
- 13 DECOMPOSED GRANITE PATH

PLANTING PLAN



PLANT SCHEDULE				
BOTANICAL NAME	COMMON NAME	MAT HEIGHT (m)	SIZE	QTY
TREES / PALMS				
An-ex	<i>Angophora costata</i>	200m	200L	2
An-co	<i>Angophora costata</i>	20m	100L	7
An-hi	<i>Angophora hispida</i>	7m	100L	1
Ba-my	<i>Baccharis myrsifolia</i>	7m	75L	4
Ce-gu	<i>Ceratopetalum gummiferum</i>	5m	75L	4
Co-gu	<i>Corimbia gummifera</i>	25m	75L	1
Cy-an	<i>Cupaniopsis anacardioides</i>	8m	100L	1
Cy-au	<i>Cyathea australis</i>	3m	1.5m Trunk	3
Cy-co	<i>Cyathea cooperi</i>	5m	1.5m Trunk	2
Ei-eu	<i>Elaeocarpus eumundii</i>	10m	100L	7
Ei-re	<i>Elaeocarpus reticulatus</i>	6-10	100L	21
Hi-ti	<i>Hibiscus tiliaceus 'Rubra'</i>	10m	100L	10
Li-au	<i>Livistona australis</i>	20m	1.8-2.2m Trunk	3
Ma-te	<i>Magnolia 'Teddy Bear'</i>	6m	75L	4
Py-co	<i>Pyrus calleryana 'Capital'</i>	15m	100L	2
Rh-ex	<i>Raphis excelsa</i>	3m	45L	10
Tr-la	<i>Tristania laurina</i>	10m	75L	11
Tr-ix	<i>Tristania laurina</i>	10m	100L	1
Pr-ce	<i>Prunus cerasifera 'Oakville Crimson Spire'</i>	6m	75L	9
SHRUBS				
Ac-mi	<i>Acmena smithii 'Goodbye Neighbours'</i>	8m	45L	42
An-ba	<i>Anthurium bakeri</i>	100mm	200mm	482
Co-et	<i>Cordyline stricta</i>	3m	45L	57
Al-im	<i>Alocaria imperialis</i>	2.5m	300mm	195
As-ni	<i>Asplenium nidus</i>	1m	300mm	107
Ca-gb	<i>Callistemon salignus 'Great Balls of Fire'</i>	1.5m	300mm	125
Ca-hi	<i>Callistemon sanguineus 'Hiryu'</i>	4m	45LT	60
Ca-wa	<i>Callistemon White Anzac'</i>	1m	300mm	60
Co-ri	<i>Correa reflexa</i>	3m	45L	8
Di-cr	<i>Dichelachne crinata</i>	1.5m	300mm	130
Fa-ja	<i>Fatsia japonica</i>	1.5m	45L	5
Mc-co	<i>Macrorhynchus communis</i>	45L	12	12
St-an	<i>Strelitzia reginae</i>	1.5m	300mm	20
St-dw	<i>Strelitzia dwarf</i>	1m	200mm	5
Sy-ca	<i>Syzygium 'Cascade'</i>	3m	45L	100
We-mu	<i>Westringia mundi</i>	0.4-0.6m	200mm	20
GROUNDCOVERS & CLIMBERS				
My-pa	<i>Myoporum parvifolium</i>	0.1m	75mm	40
Ca-co	<i>Casuarina glauca 'Cousin it'</i>	0.1m	75mm	140
To-bo	<i>Toda barbera</i>	1m	200mm	445
Lo-lo	<i>Lomandra Little Con</i>	0.3m	75mm	670
Vi-he	<i>Viola hederacea</i>	0.1m	75mm	630
Di-ca	<i>Dianella caerulea var. producta</i>	0.2m	150mm	545
Pa-ha	<i>Pandorea pandorana</i>	0.1m	75mm	20
Ad-im	<i>Adiantum hispidulum</i>	0.3m	200mm	70
Cl-im	<i>Clivias miniata</i>	0.3m	200mm	140
Ev-pl	<i>Evolvulus pilosus 'Sapphire Blue'</i>	0.3m	200mm	50
Ca-gl	<i>Carpobrotus glaucescens</i>	0.15m	150mm	25
No-lo	<i>Notondronia longifolia</i>	1m	300mm	130
Pe-se	<i>Perennanthes setaceum rubrum</i>	1m	300mm	130
He-gl	<i>Heimholzia glomerata</i>	1m	300mm	700
Tr-ja	<i>Trachelospermum jasminoides</i>	0.2m	200mm	14

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LA06

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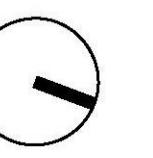
TREE RETENTION AND REMOVAL PLAN

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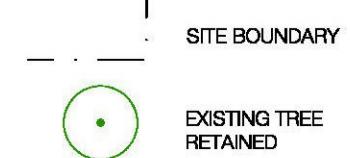
project: 47 Murray Farm Rd, Carlingford
client: Japara Healthcare
date: 12.09.2019
revision: B
drawn: RY
checked: DMT

LA07



SCALE 1:200 @ A1
0 2 4 8 12m

LEGEND




SITE BOUNDARY



EXISTING TREE
RETAINED



EXISTING TREE
REMOVED

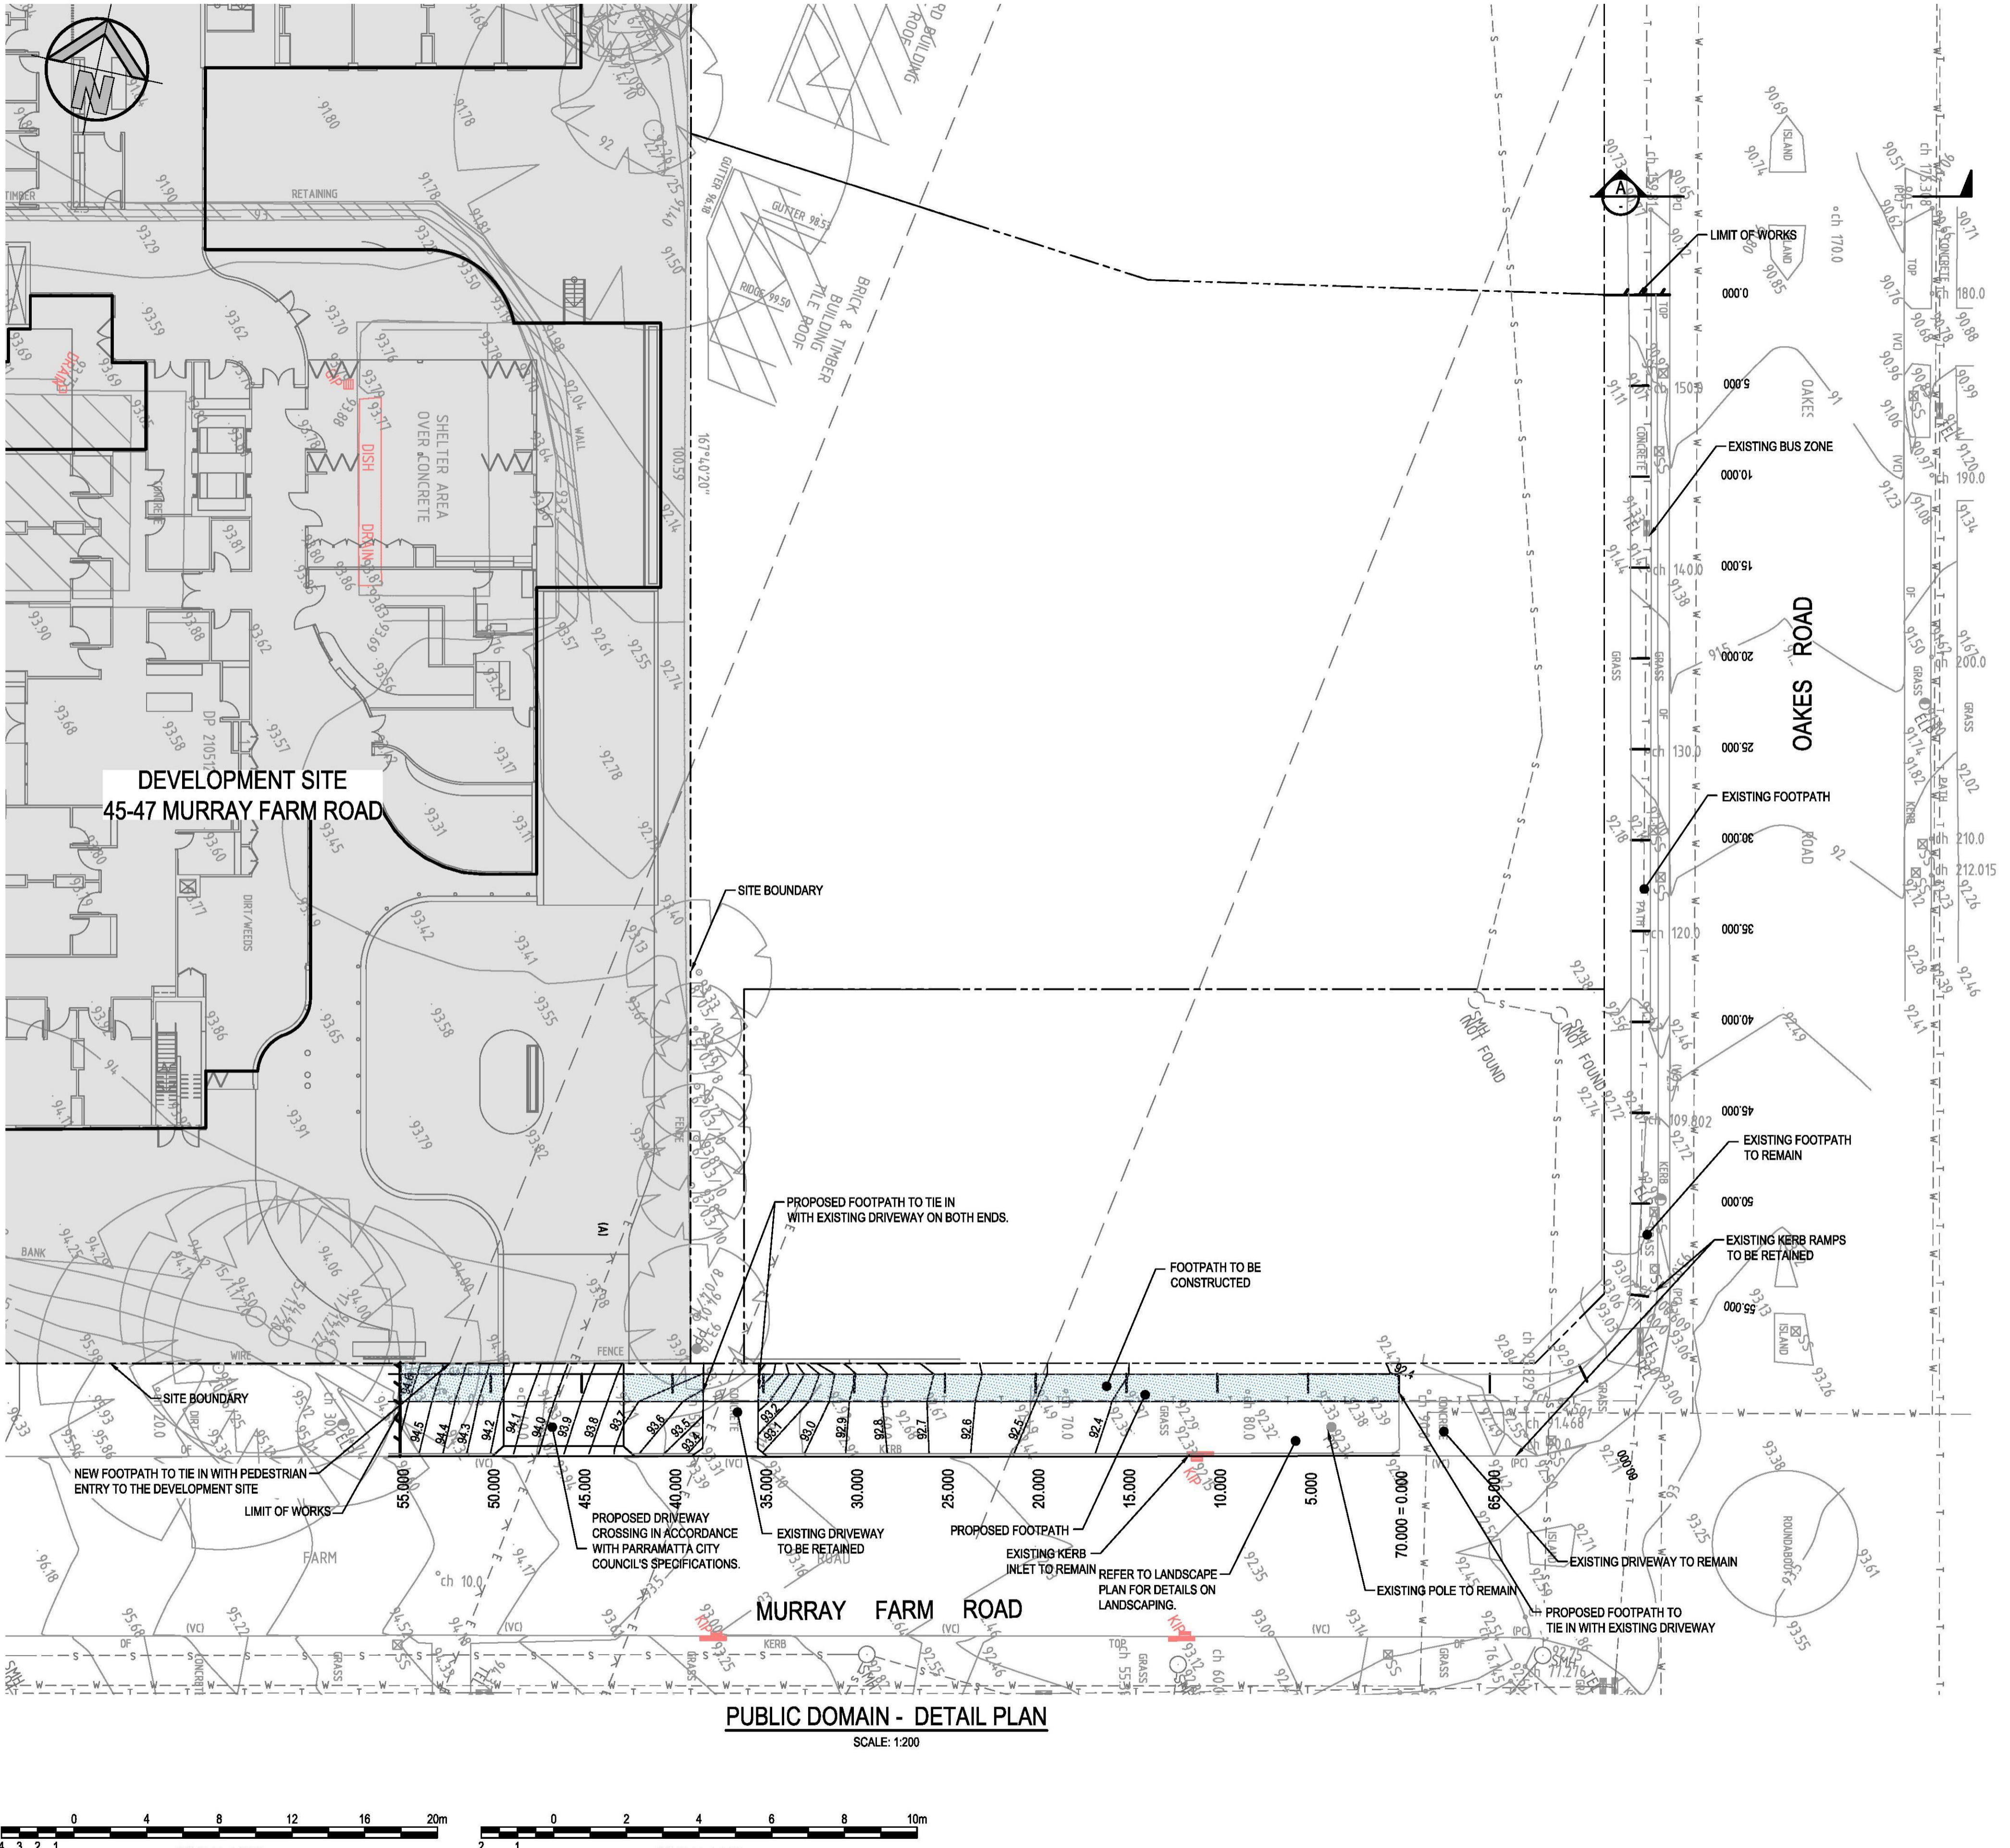

EXISTING INFORMATION
EXISTED BY
LTS LOCKLEY
DATUM A.H.D.
ORIGIN OF LEVELS: SSM107070 RL108.675


02 ISSUED FOR APPROVAL	JK	IA	05.09.2019
01 ISSUED FOR APPROVAL	MS	IA	02.08.2019
REVISION	AMENDMENT	DRAWN	DESIGNED DATE

SCALE 1:200

SCALE 1:100

Client
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Architect
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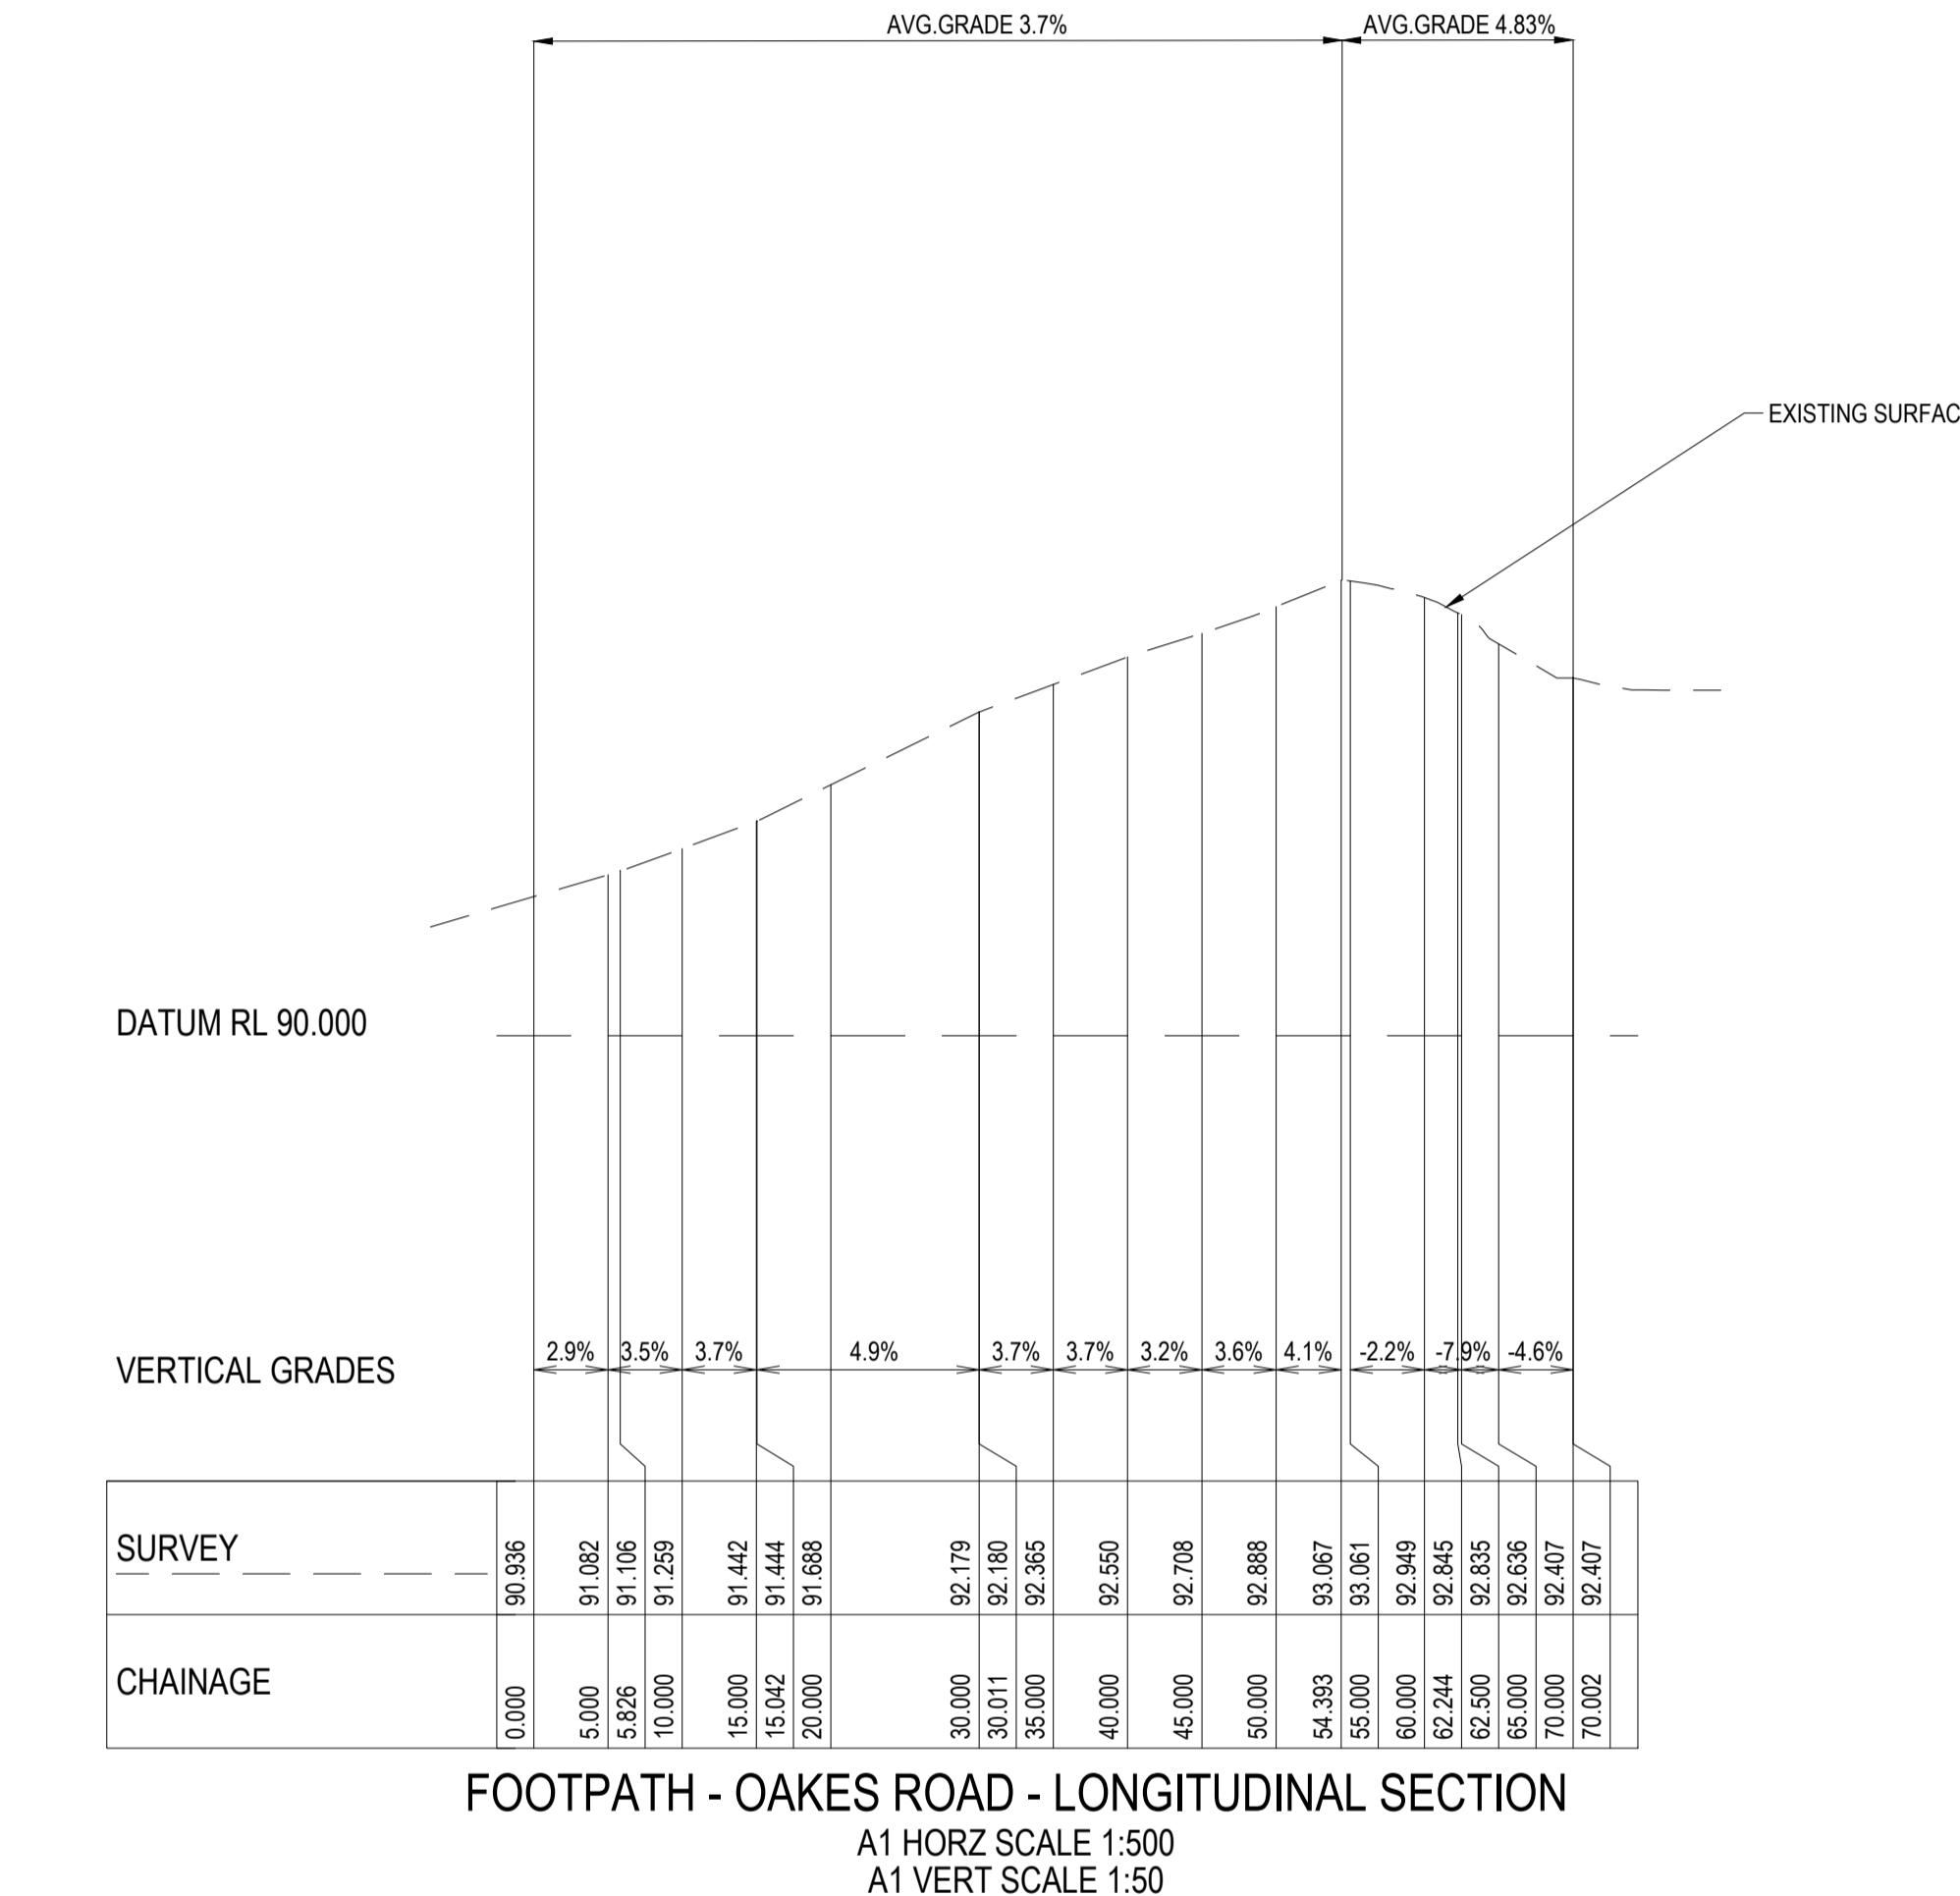
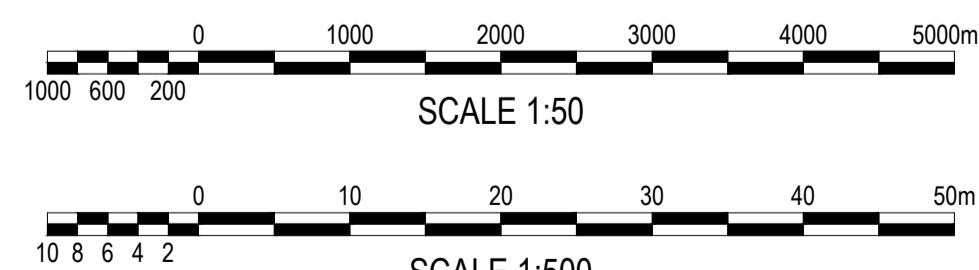
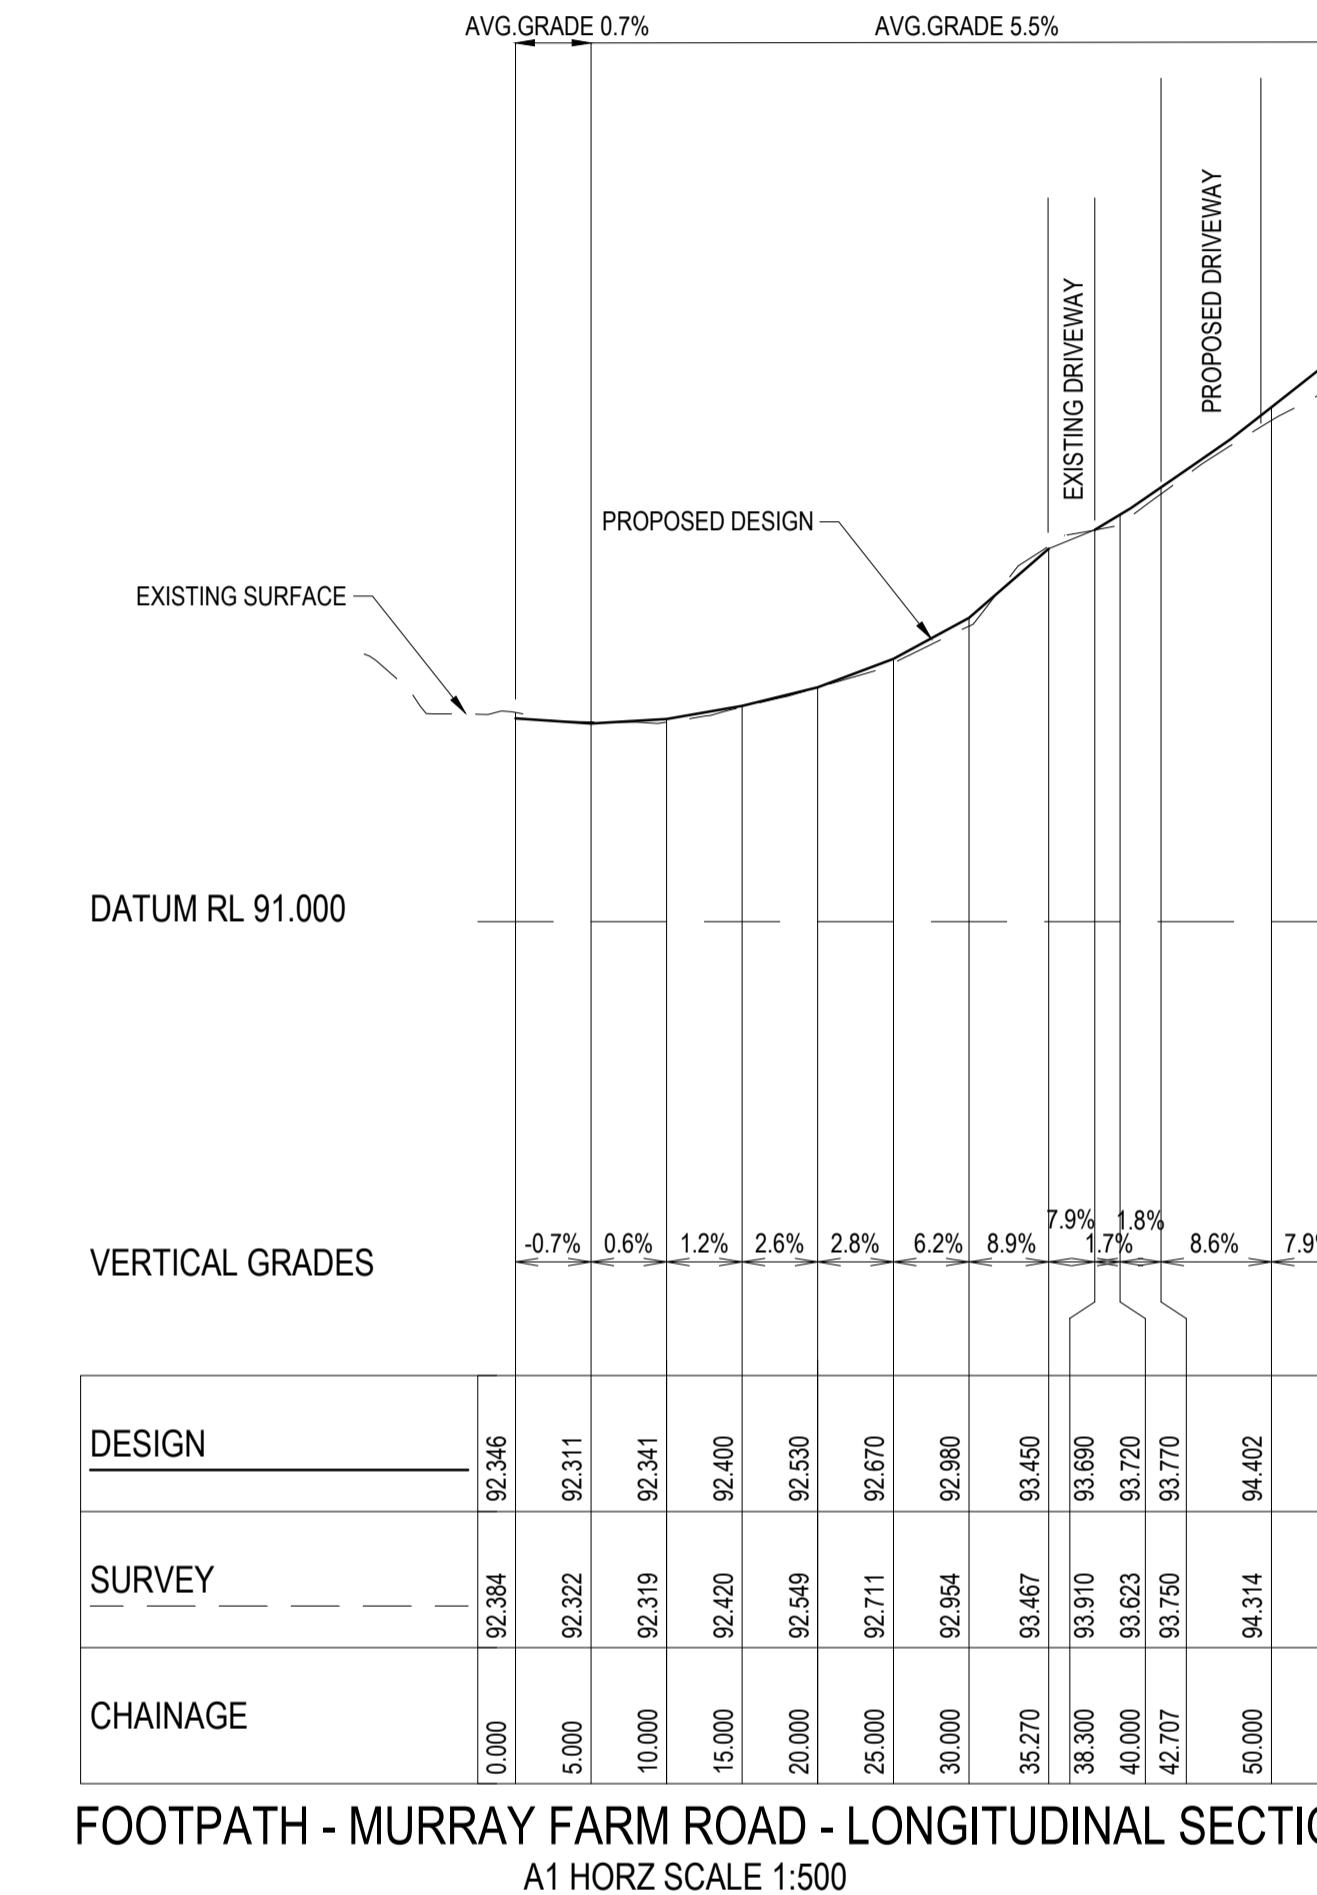
Project
PROPOSED AGED CARE DEVELOPMENT
47 MURRAY FARM ROAD, CARLINGFORD NSW

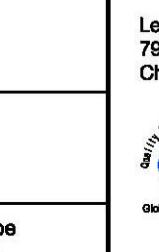

Title
PUBLIC DOMAIN - DETAIL PLAN
Drawing number
16833_DA_EX100
Revision
02

ISSUED FOR APPROVAL

Drawn M.Sirinova	Designed I.Ahmed	Date JULY 2019
Checked A.Francis	Approved A.Francis	Scale 1:200 A1
Drawing number 16833_DA_EX100	Revision 02	




ISSUED FOR APPROVAL

SURVEY INFORMATION	
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Datum A.H.D.	
Origin of Levels:	SSM10707 RL108.675
Revision	AMENDMENT
Drawn	Designed
Amendment	Date
Revision	Amendment
Drawn	Designed
Amendment	Date
Drawn	Designed
Amendment	Date

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Architect
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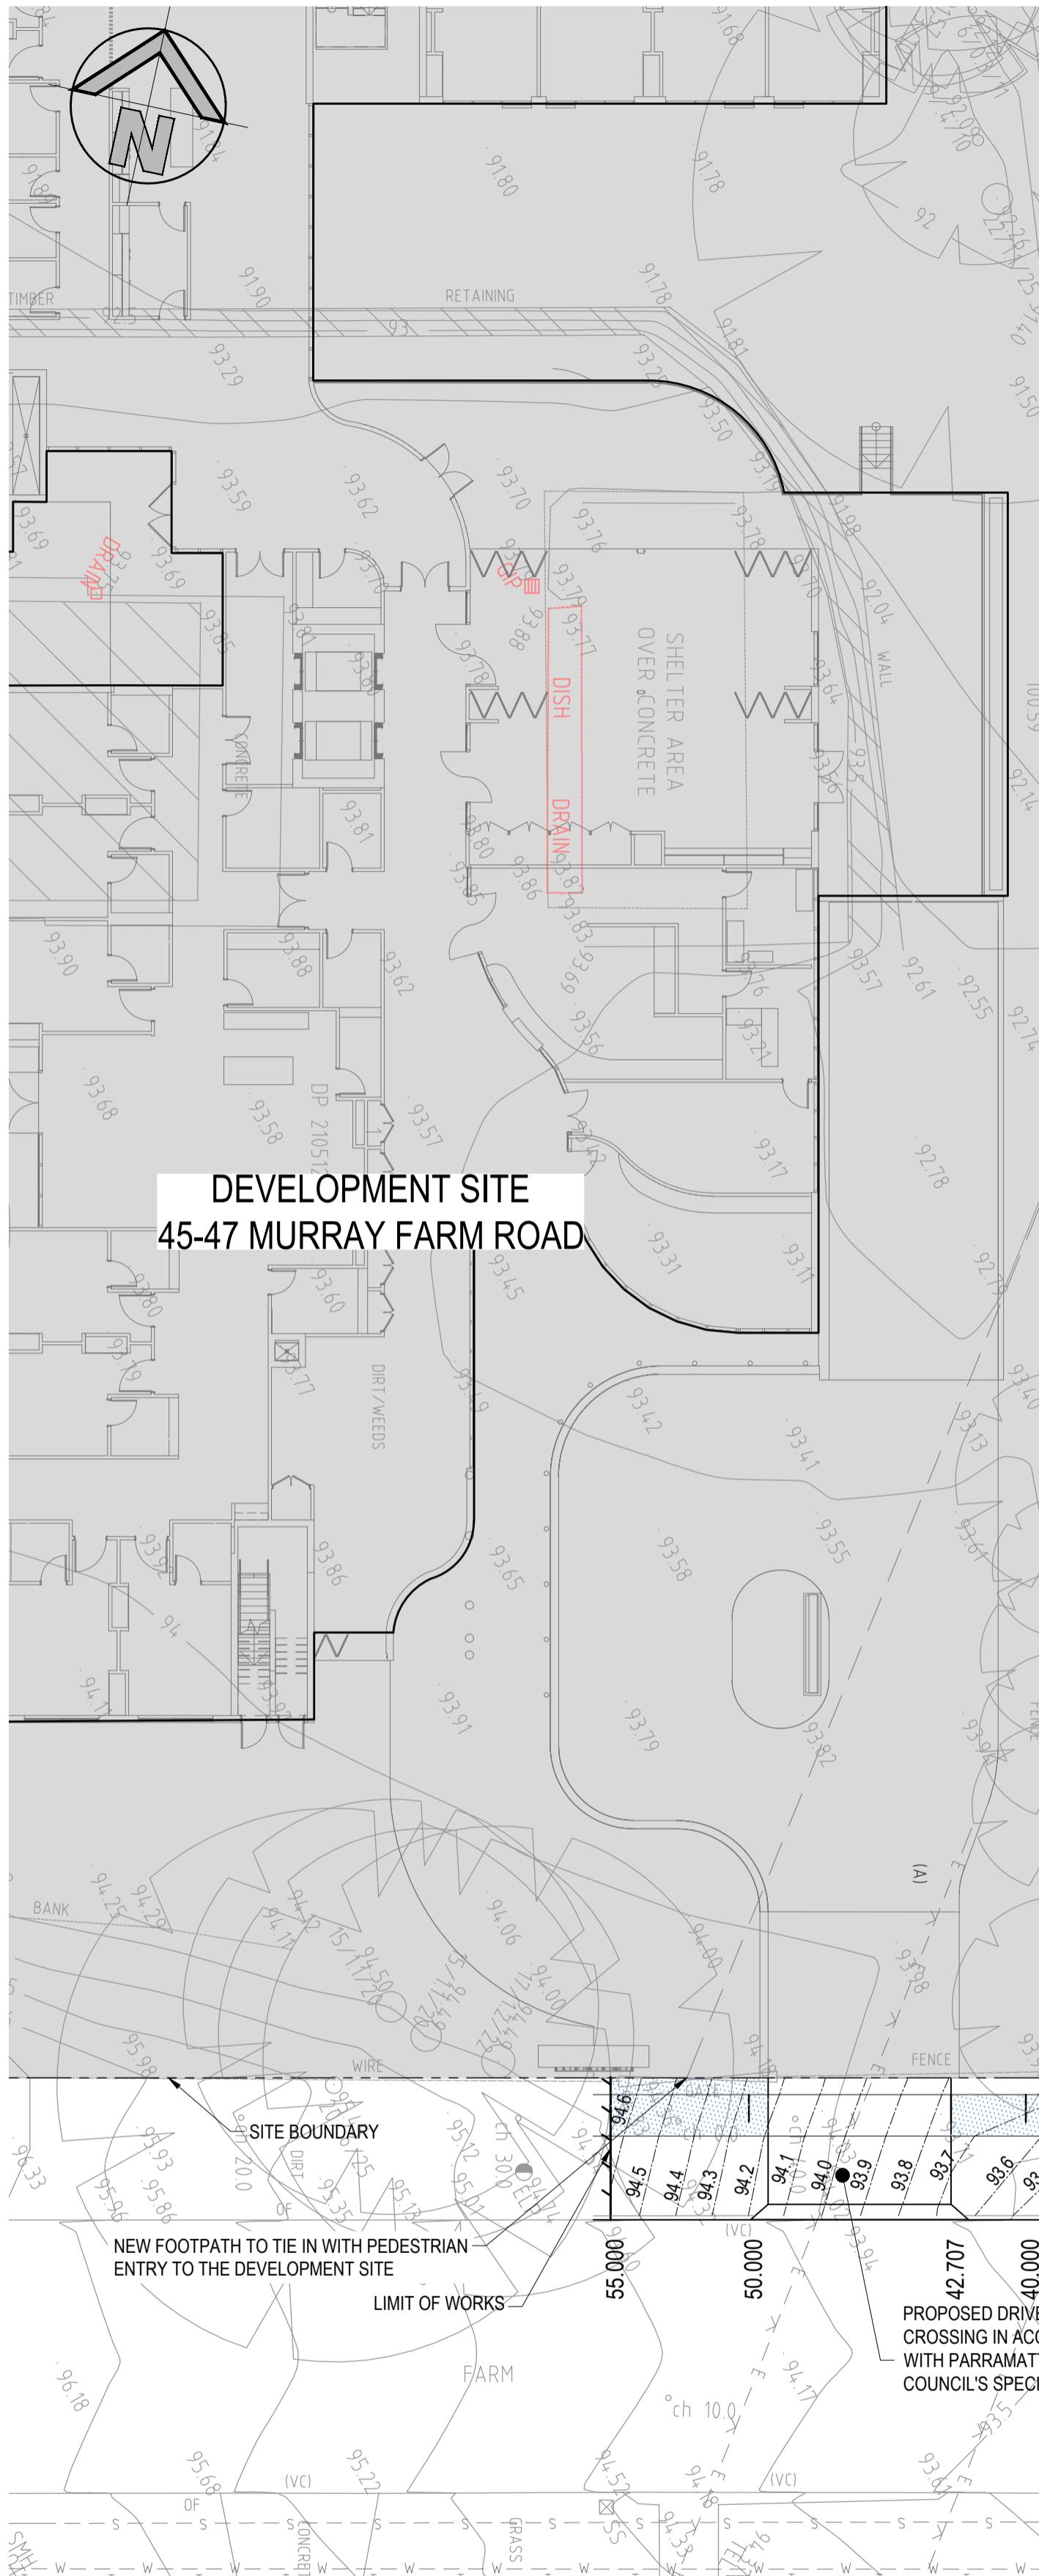


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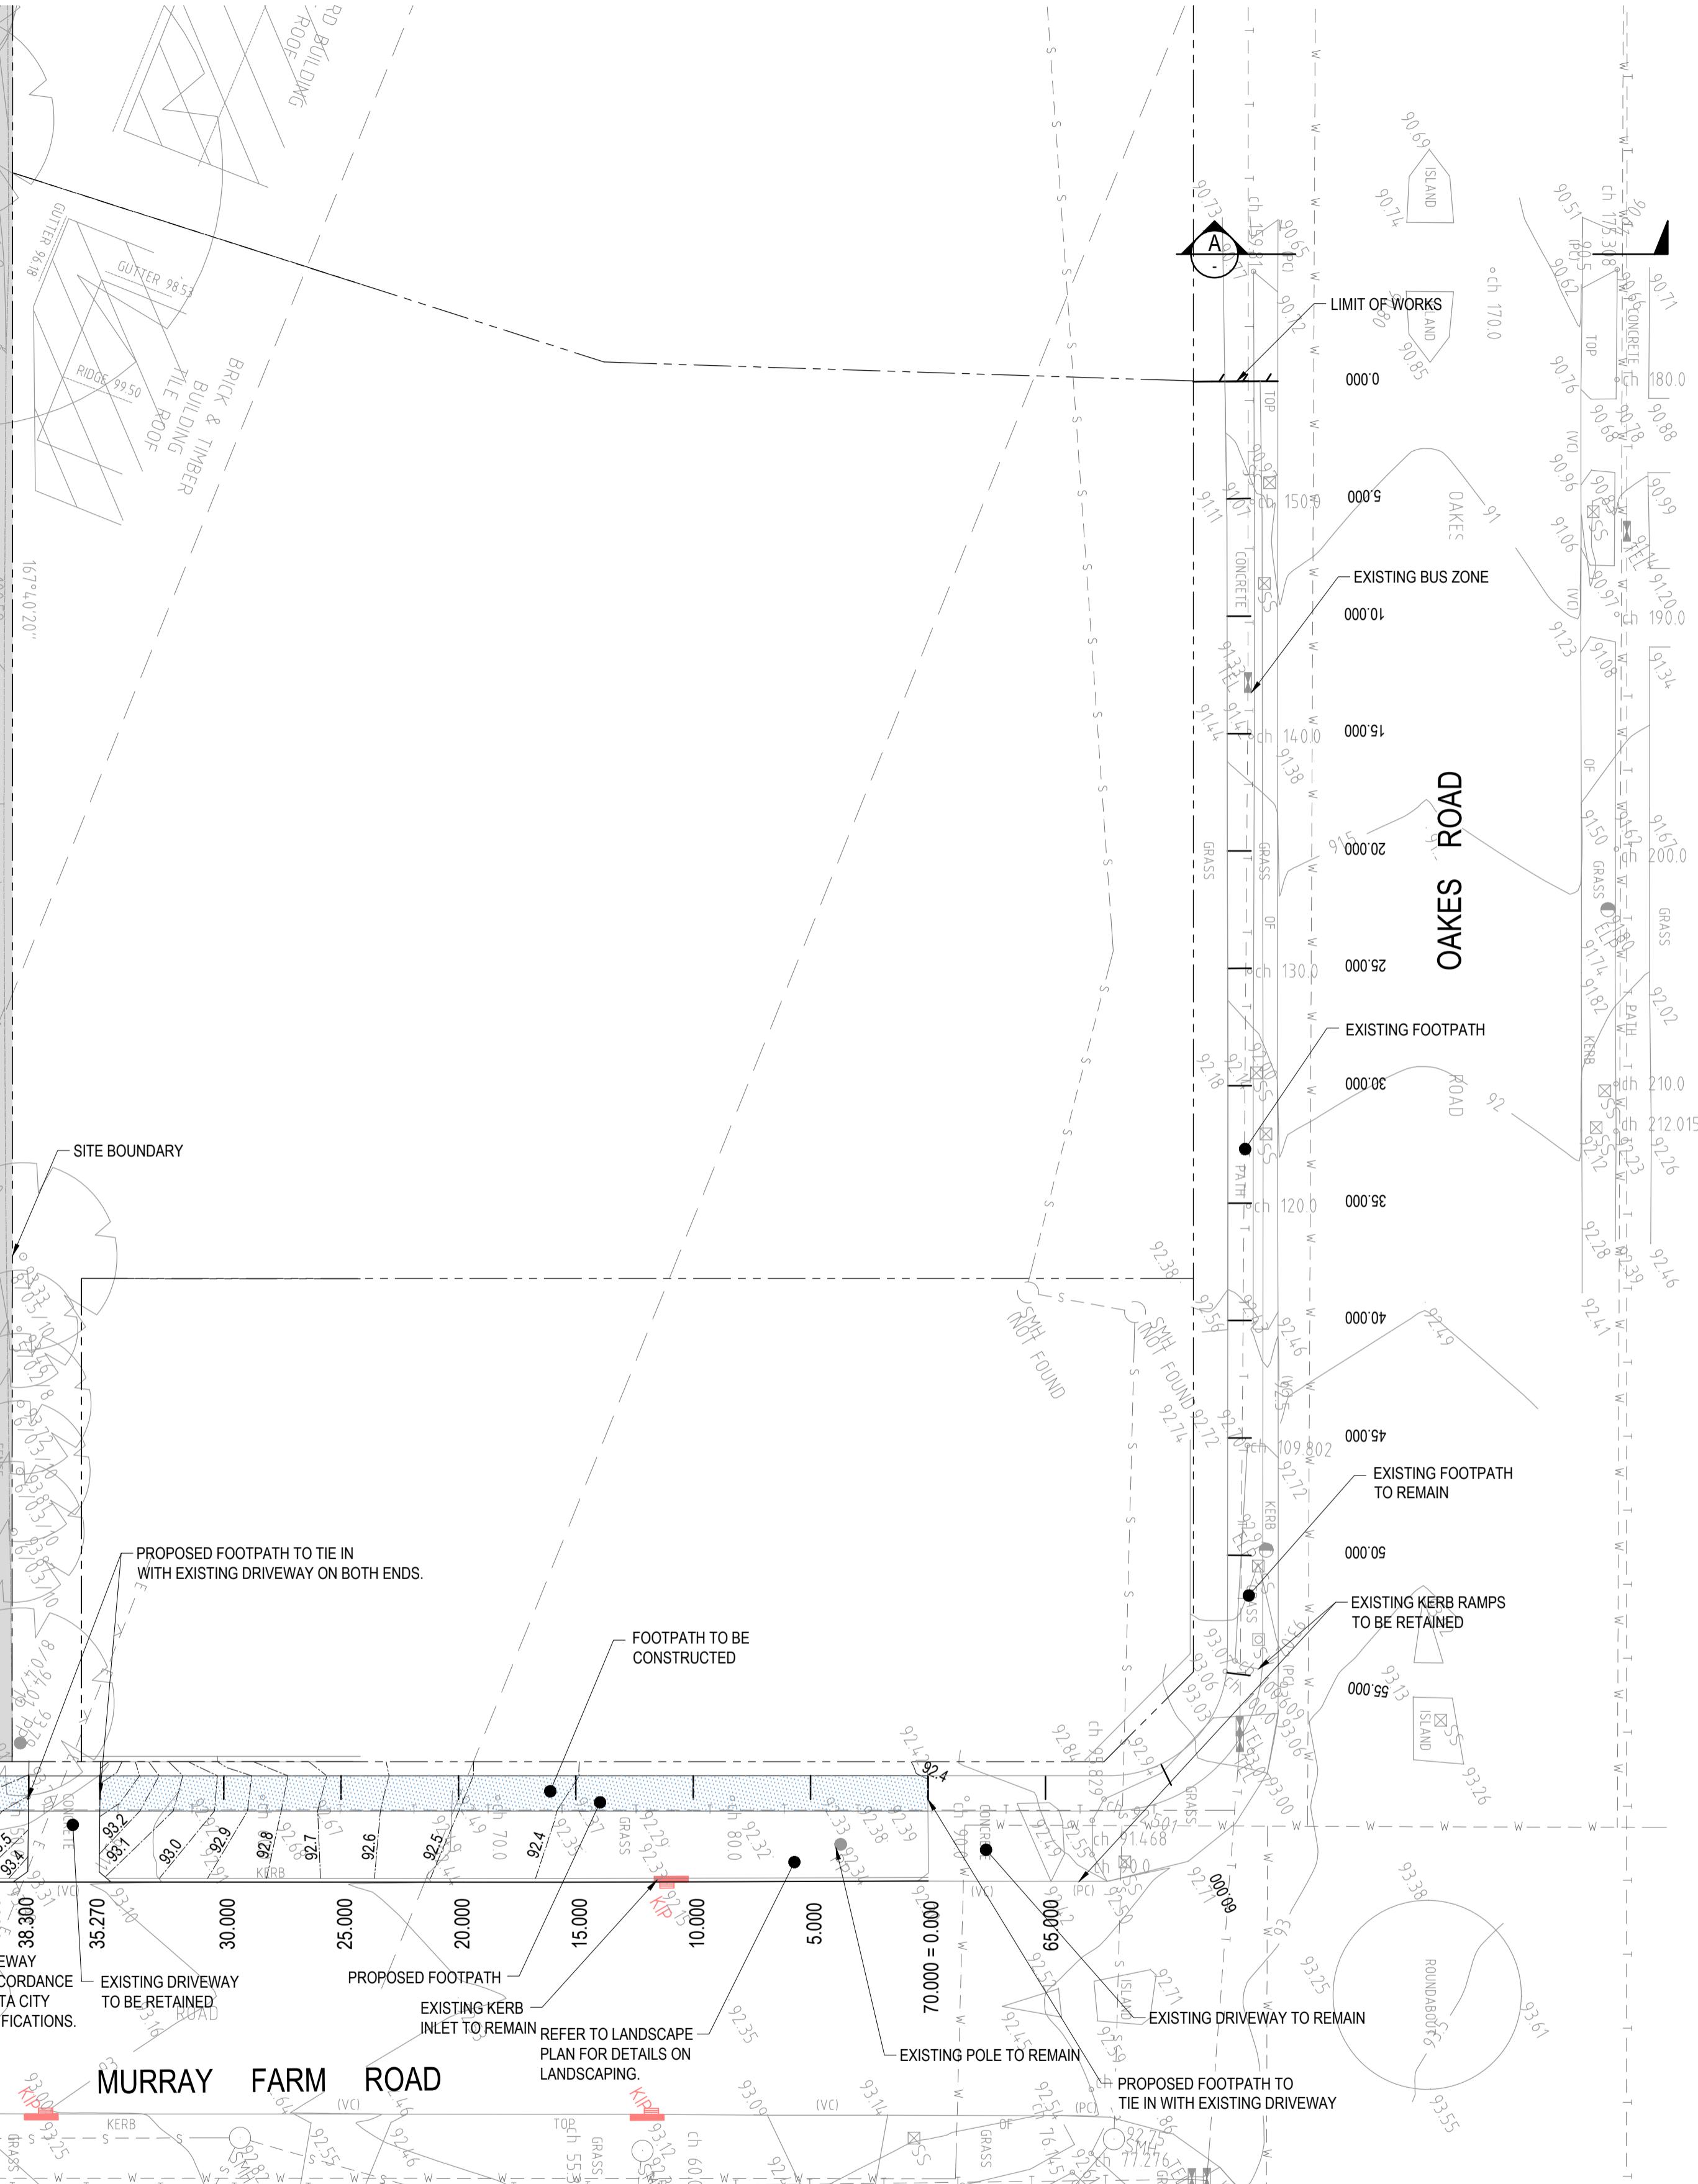


Project
PROPOSED AGED CARE DEVELOPMENT
47 MURRAY FARM ROAD, CARLINGFORD NSW
Title
ROADS LONGITUDINAL SECTIONS

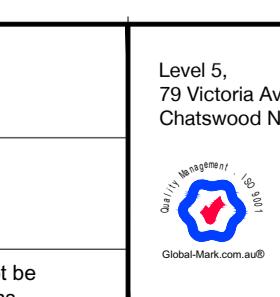Drawn
M.Stimova
Designed
I.Ahmed
Date
JULY 2019
Checked
A.Francis
Approved
A.Francis
Scale @ A1
AS SHOWN @ A1
Drawing number
16833_DA_EX120 02
Revision




EXISTING INFORMATION	
EXISTED BY LTS LOCKLEY	
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02	ISSUED FOR APPROVAL
01	ISSUED FOR APPROVAL
REVISION	AMENDMENT
DRAWN	DESIGNED
DATE	REVISION
AMENDMENT	DRAWN
DESIGNED	DATE
REVISION	AMENDMENT




SCALE 1:200

SCALE 1:100

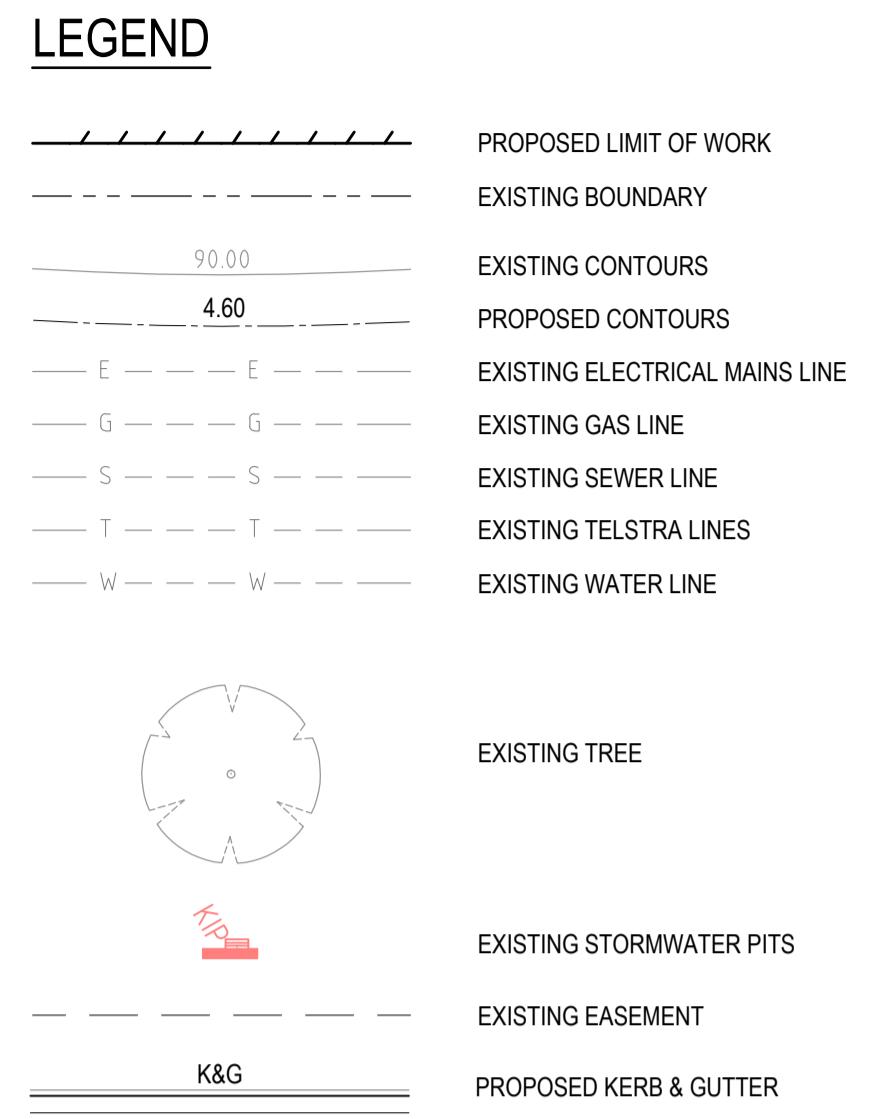


NOTE:

- REFER TO LANDSCAPE ARCHITECT'S DRAWINGS FOR DETAILS
- REFER TO DRAWING EX120 FOR ROAD LONG SECTIONS
- REFER TO DRAWING EX130-EX131 FOR ROAD CROSS SECTIONS.

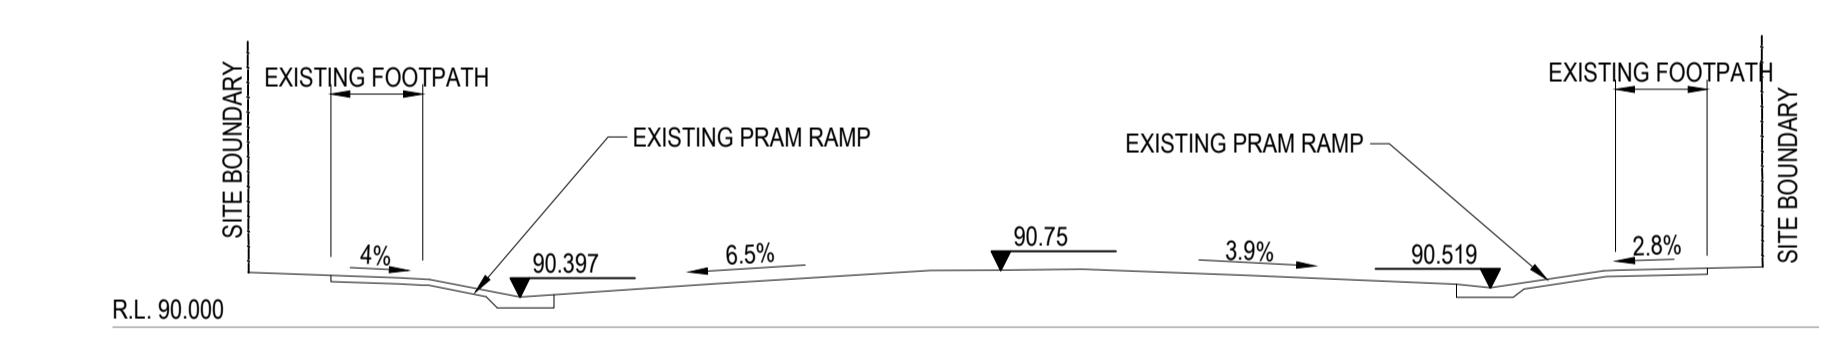

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Architect THOMSON ADSETT		
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PROPOSED AGED CARE DEVELOPMENT
47 MURRAY FARM ROAD, CARLINGFORD NSW

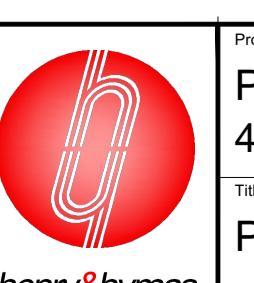PUBLIC DOMAIN - DETAIL PLAN

Drawn
M.Stimova
Designed
I.Ahmed
Date
JULY 2019

Checked
A.Francis
Approved
A.Francis
Scale @A1
1:200 @ A1

Title
Drawing number
16833_DA_EX100 03